

# School of Medicine – CRF/DM Building 4 Mechanical Renovations State Project # H27-N258

COLUMBIA, SC

A/E Project #11060.03 OCTOBER 25, 2012 ISSUED FOR CONSTRUCTION

Prepared by:



ASSOCIATES, INC.

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S101 ROOF FRAMING PLAN

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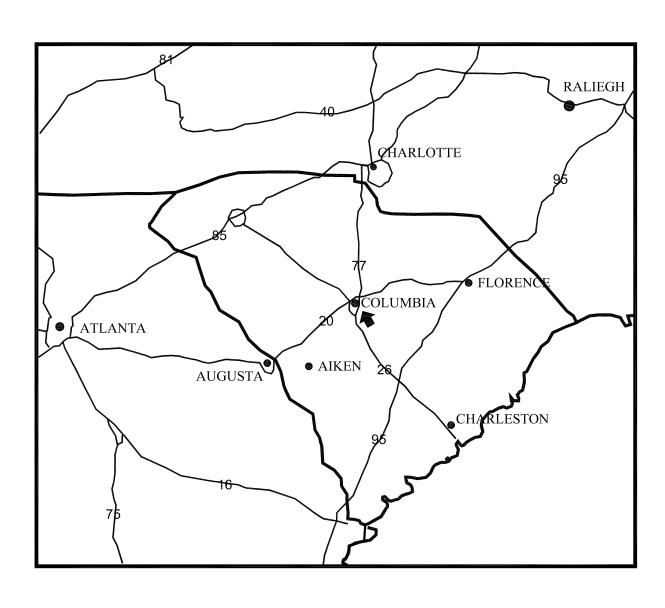
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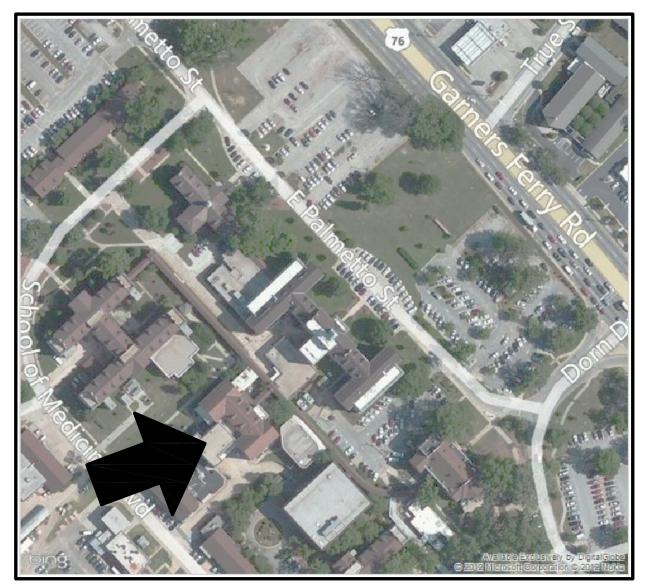
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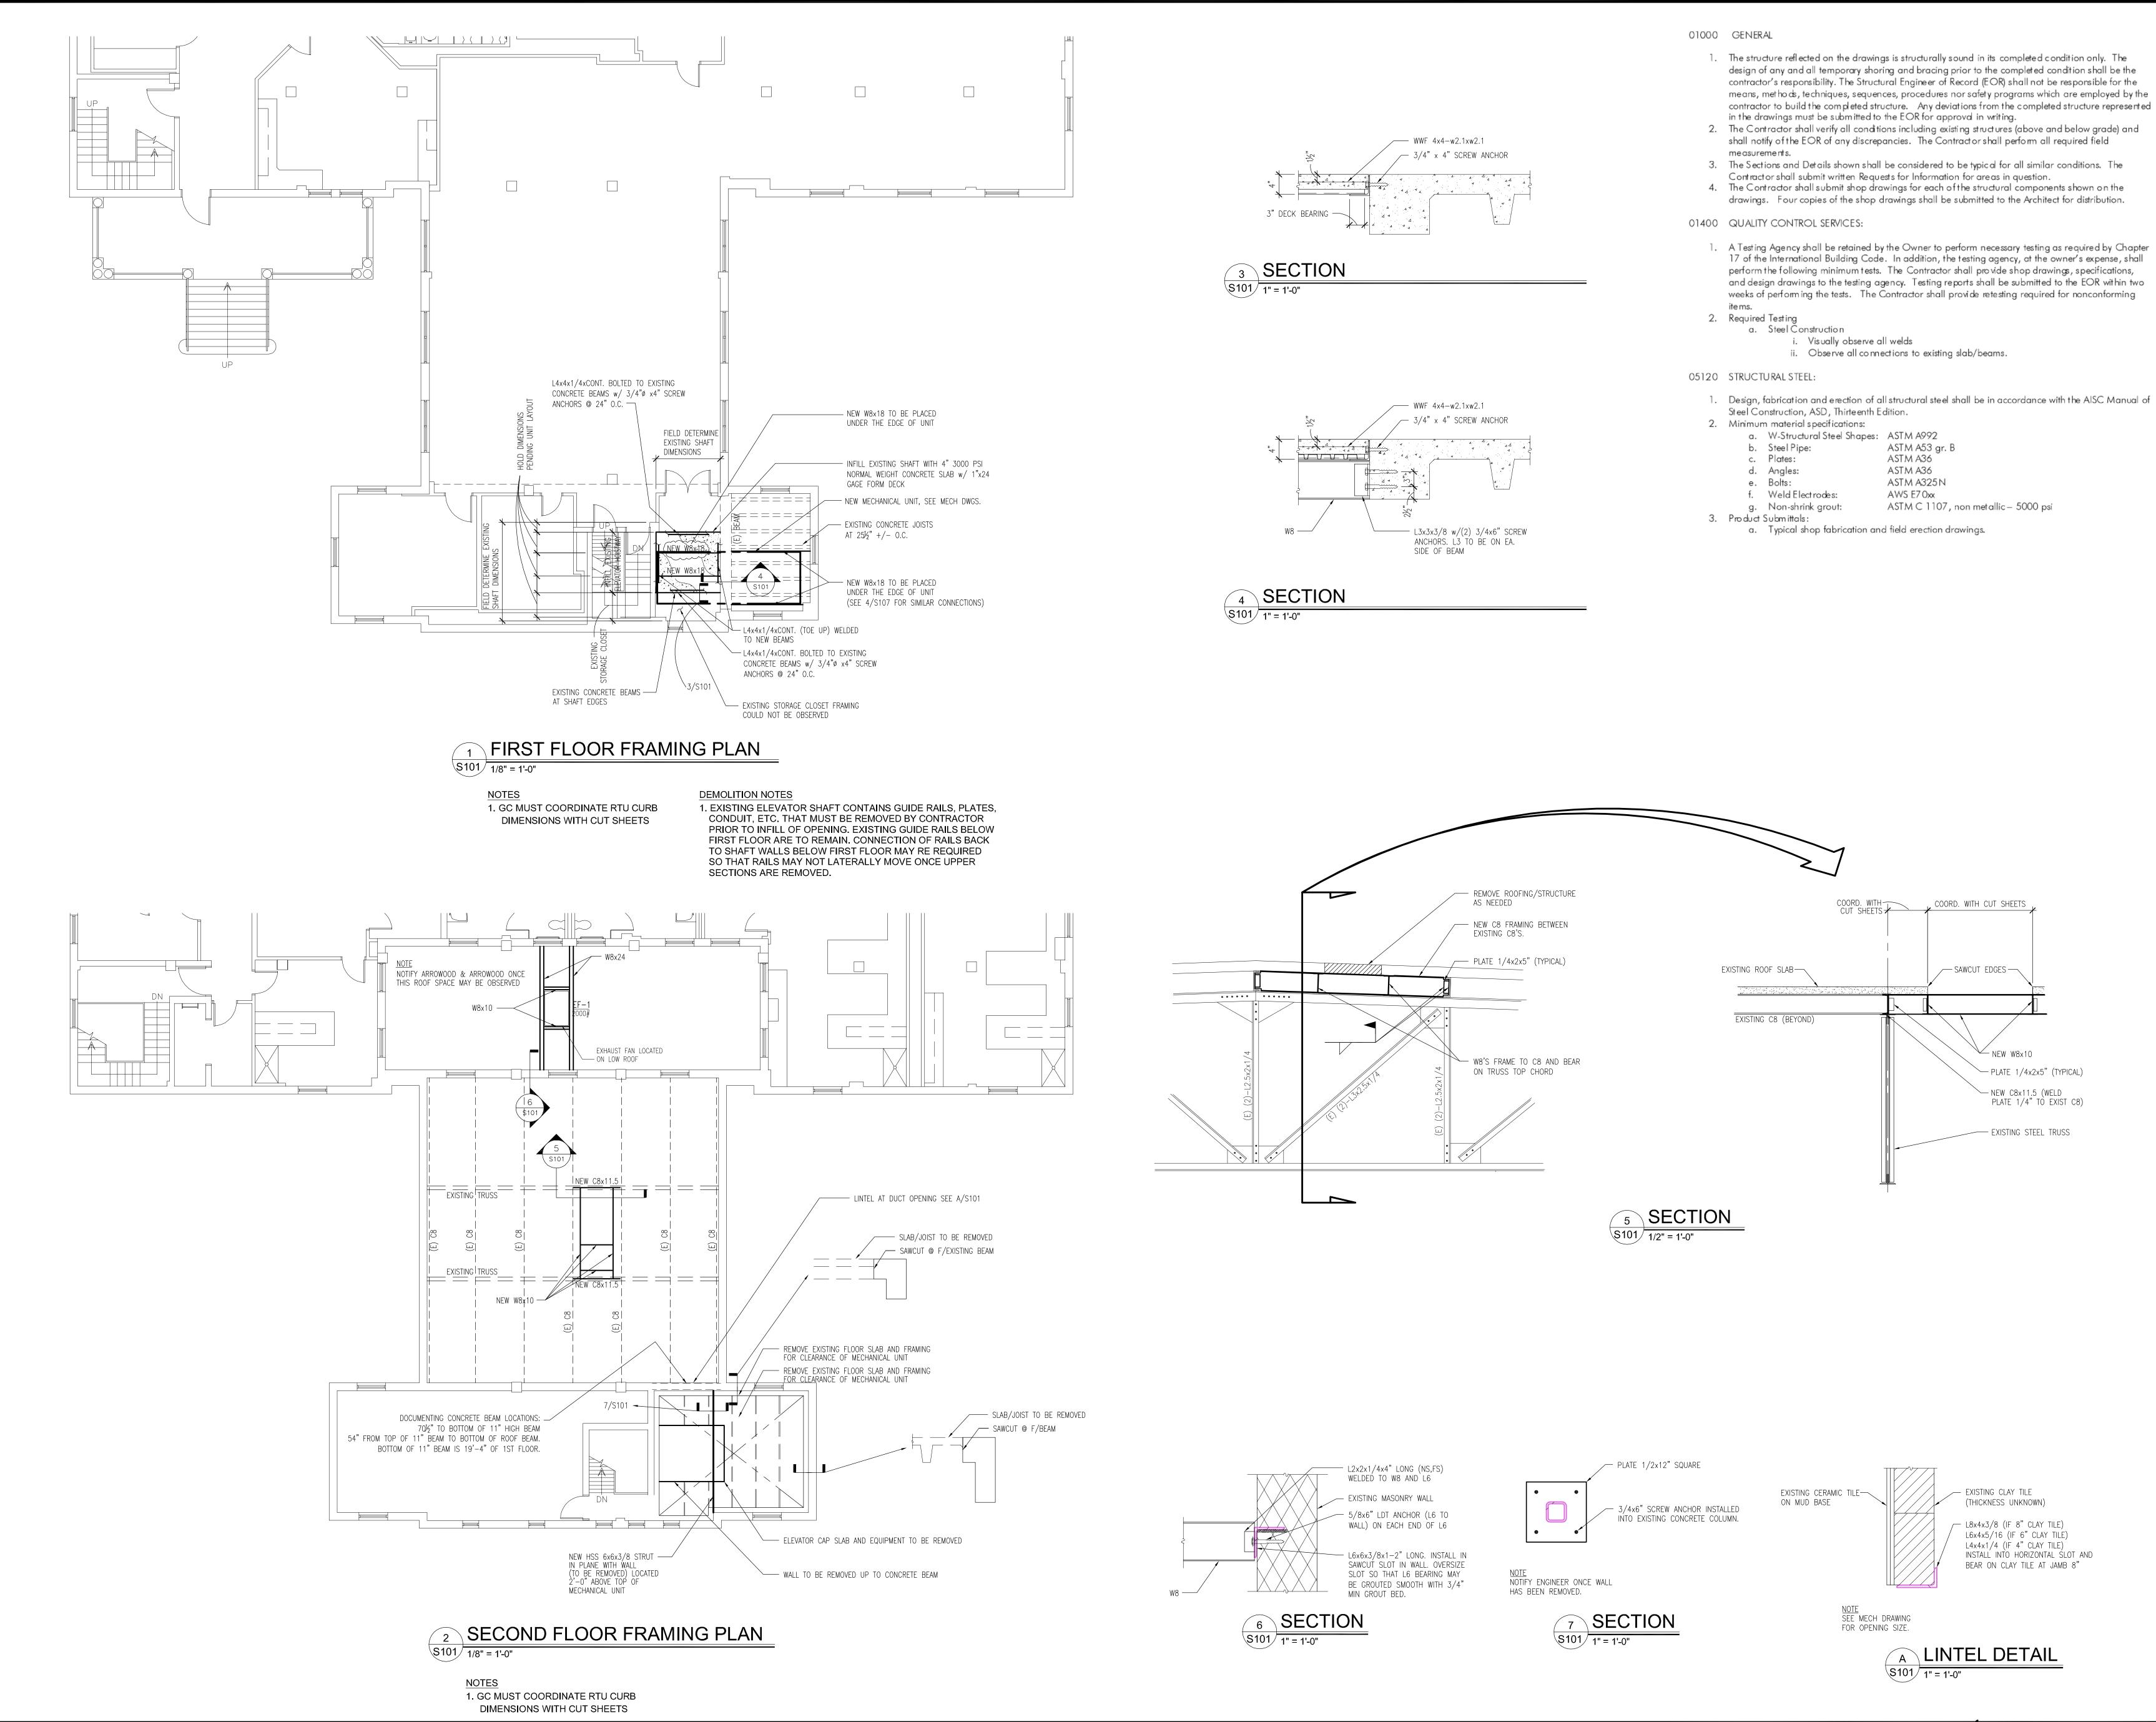
### **ELECTRICAL**

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University of South Carolina School of Medicine

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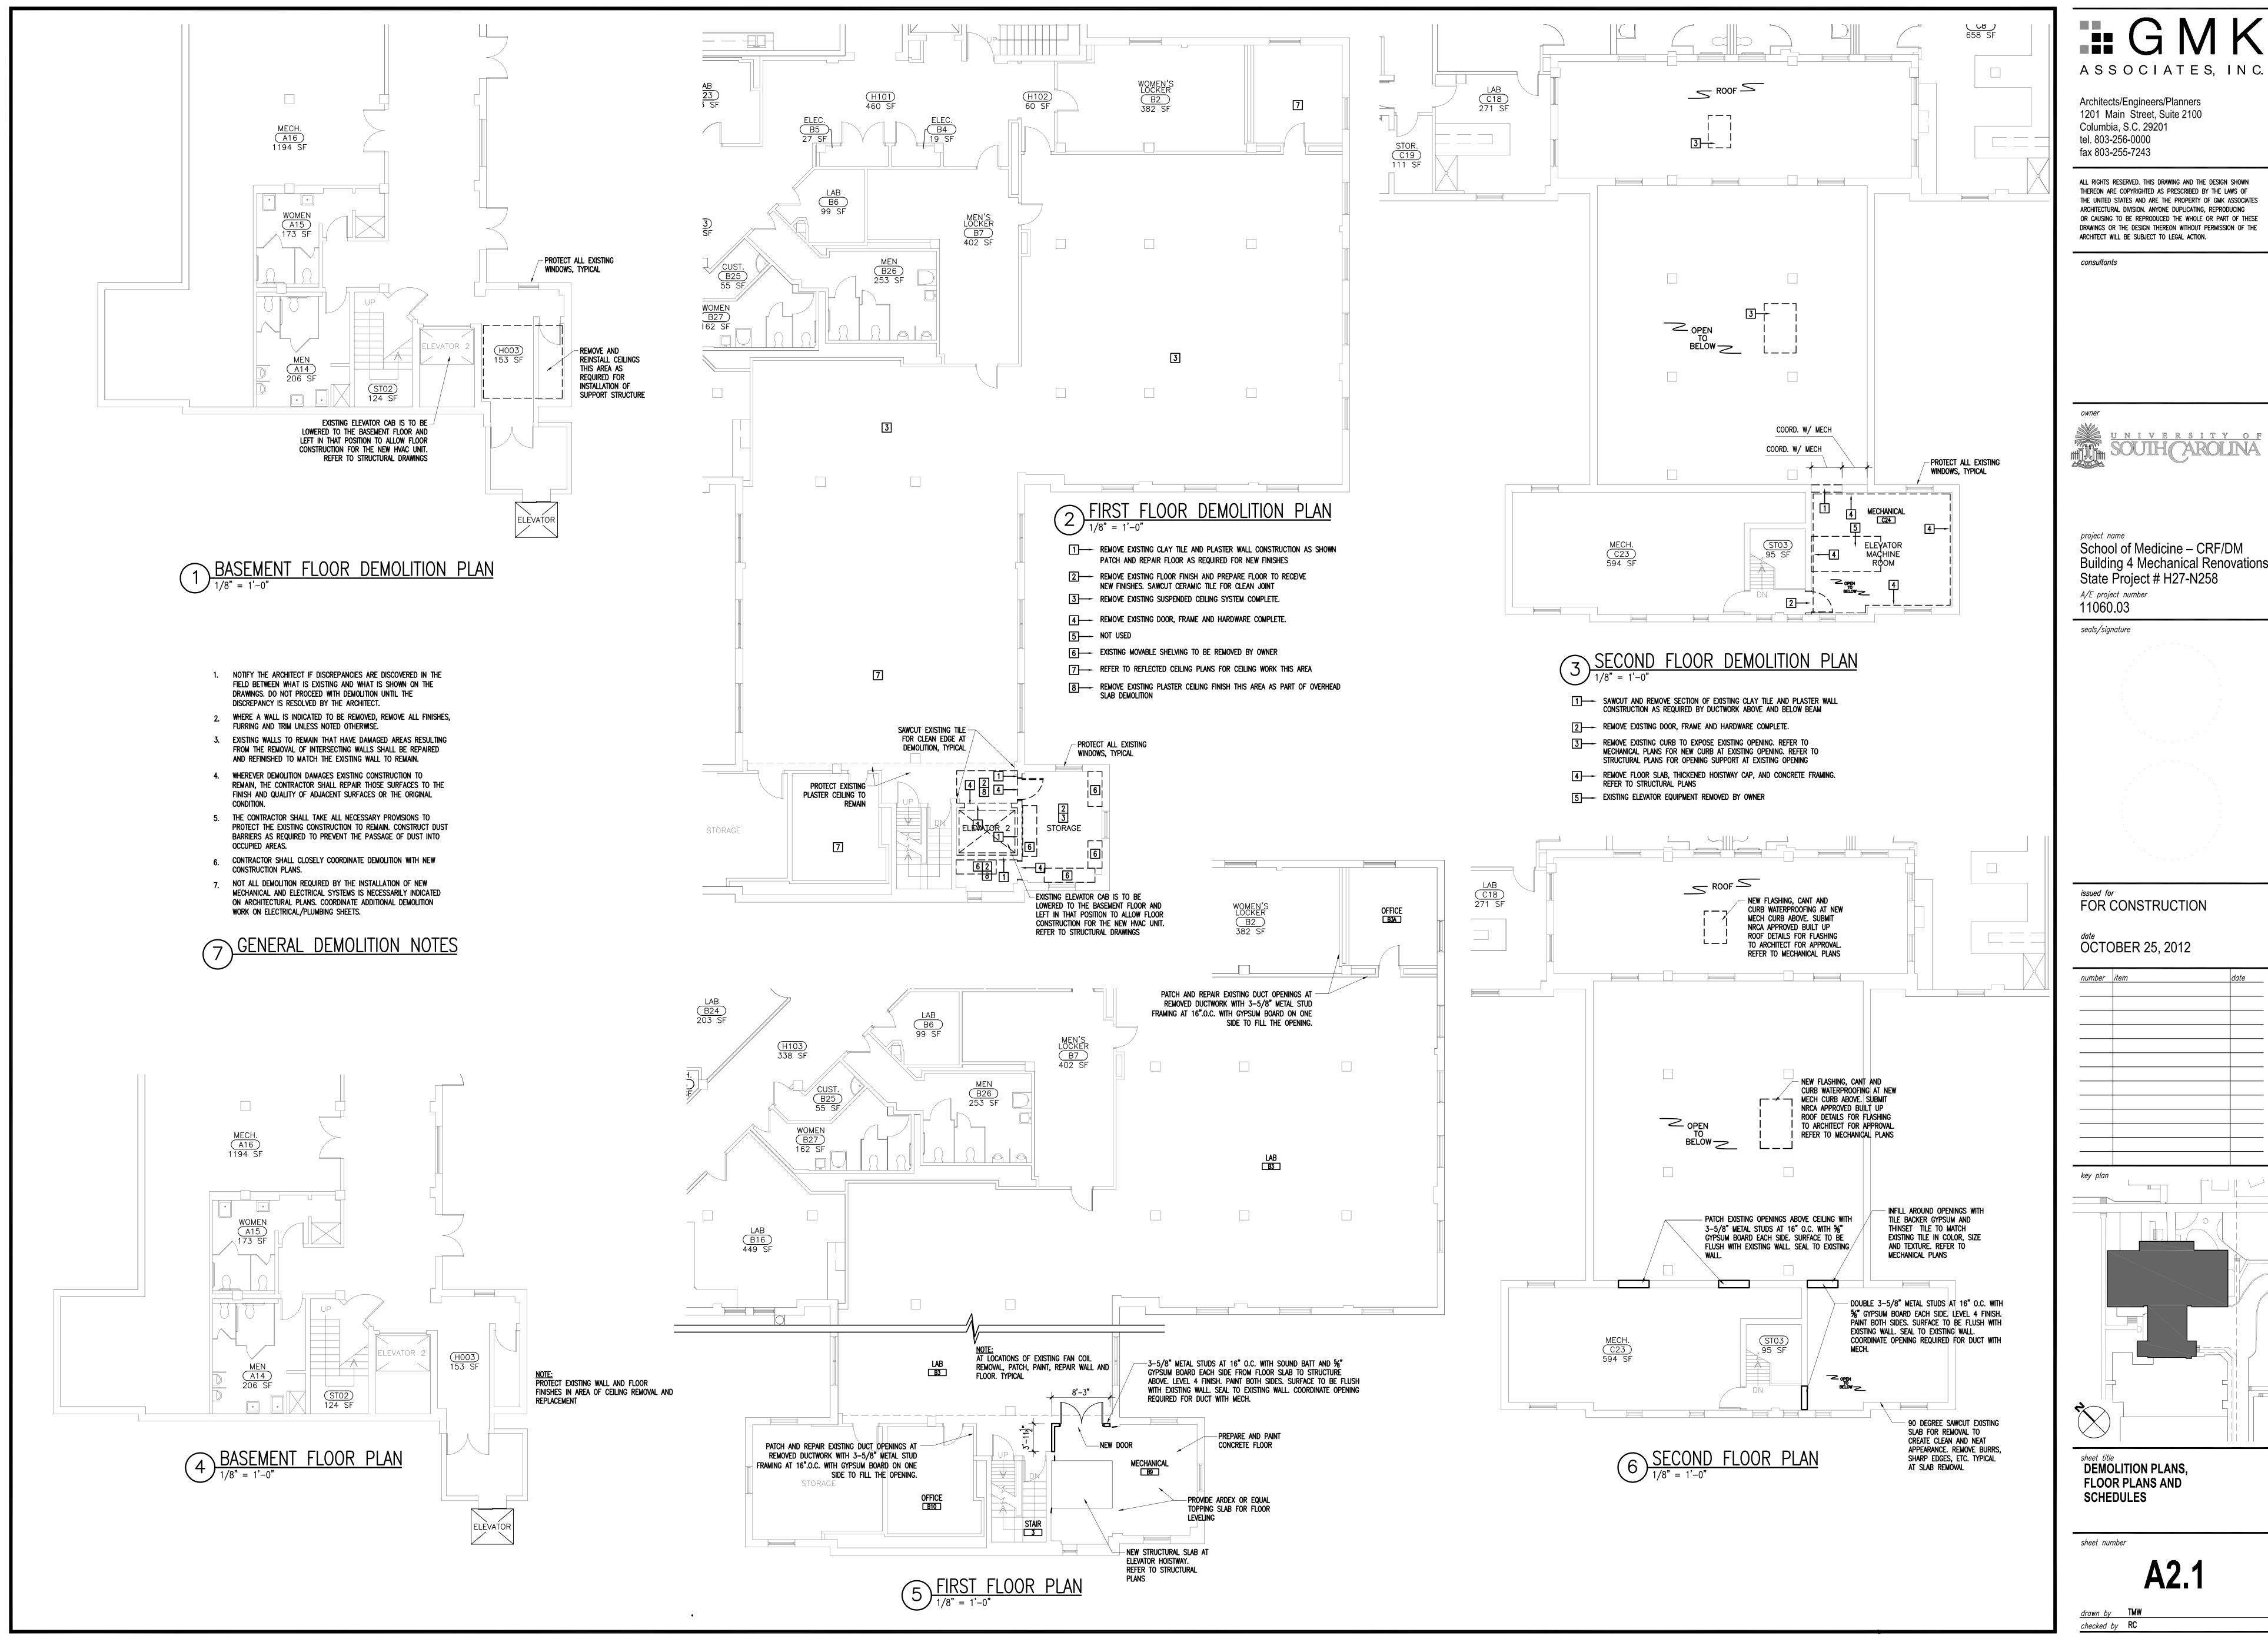
ADDENDUM 10/25/12

sheet title

STRUCTURAL PLANS

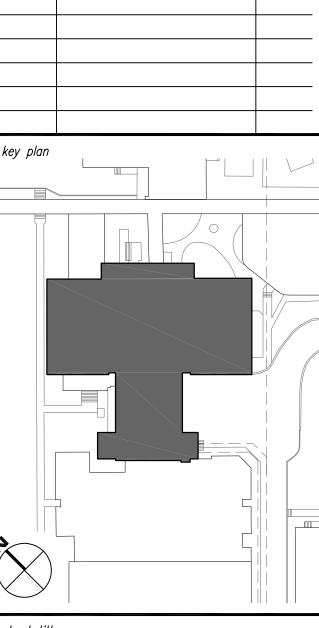
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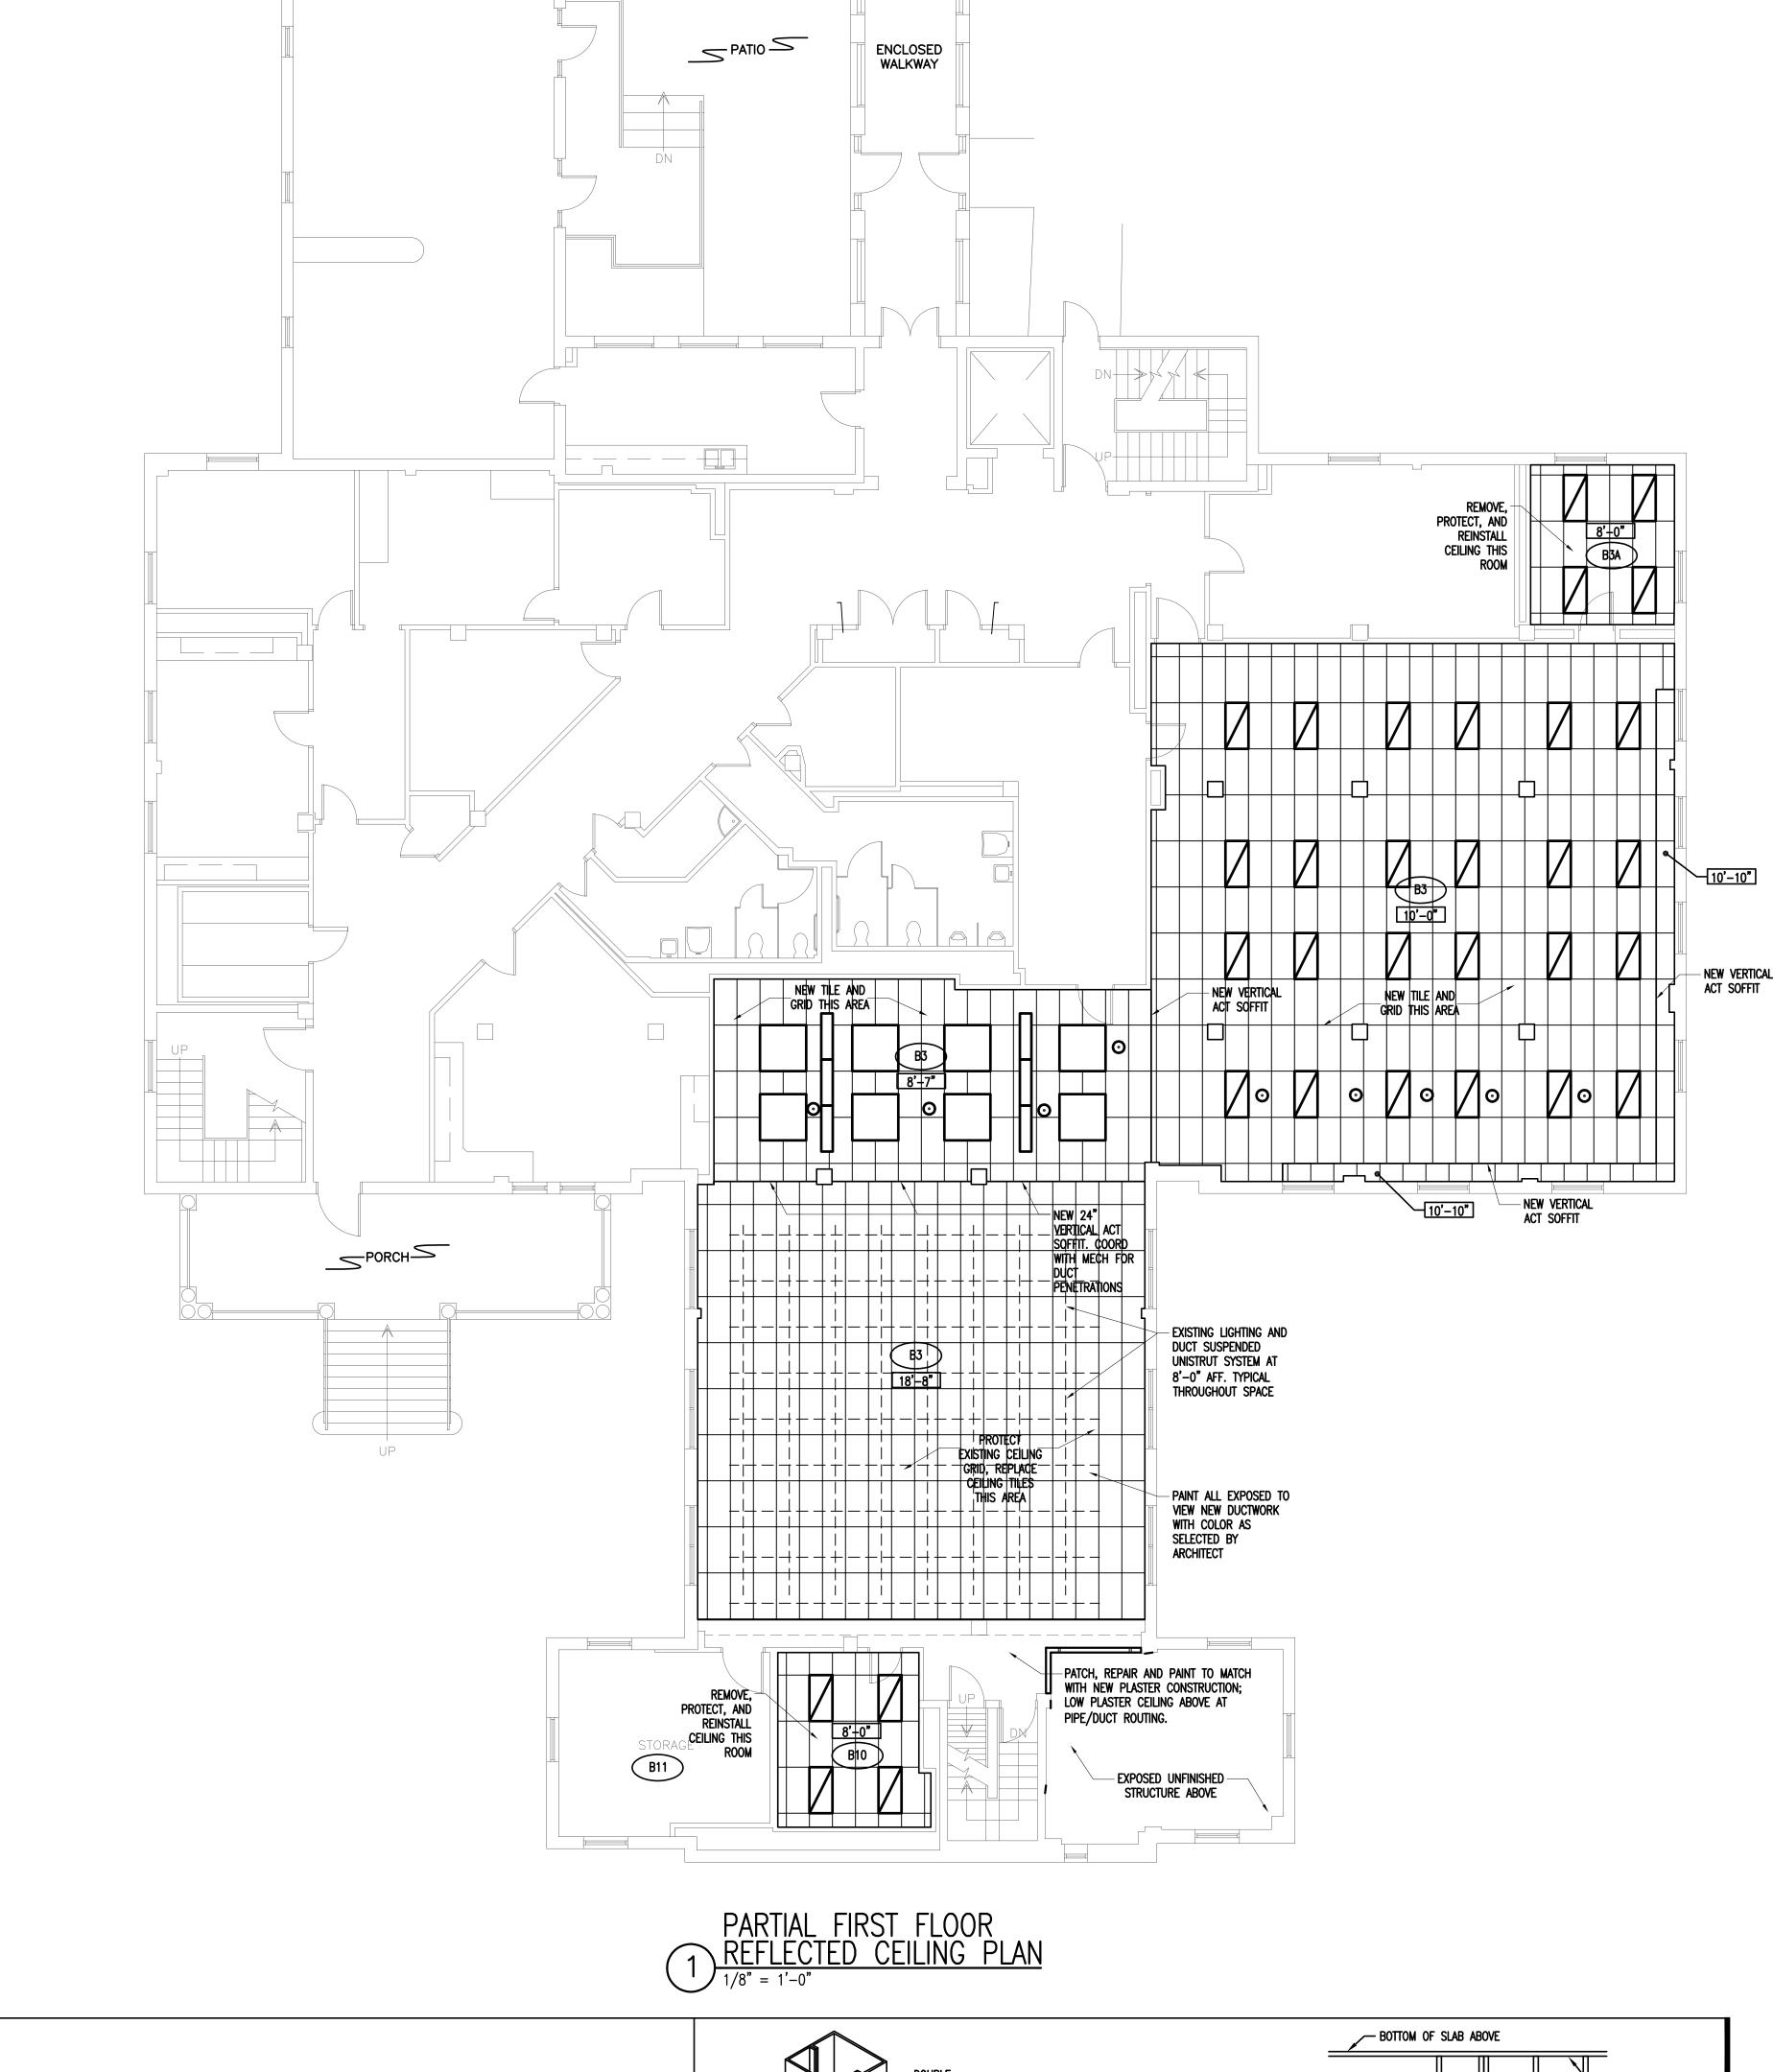
S101



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Building 4 Mechanical Renovations





DOOR DOOR NUMBER ELEV FRAME HDWR ELEV SET REMARKS DOOR SIZE ROOM NAME 6'-0" X 7'-0" В3 a STOR

DOOR HARDWARE:

1. ALL HARDWARE TO BE BHMA OPERATIONAL GRADE 1 — HEAVY DUTY COMMERCIAL.

2. ALL HARDWARE SHALL MEET ANSI 117.1 AND ADA AS APPLICABLE.

3. FINISH SHALL BE SATIN NICKEL.

4. KEYING SHALL BE COORDINATED WITH OWNER AND KEYS PROVIDED. 5. EXACT TRIM, FINISH AND STYLE SHALL MATCH EXISTING HARDWARE IN THE SPACE.

6. HARDWARE SUPPLIER SHALL COORDINATE WITH DOOR AND FRAME SUPPLIER ON PREPARATION FOR HARDWARE.

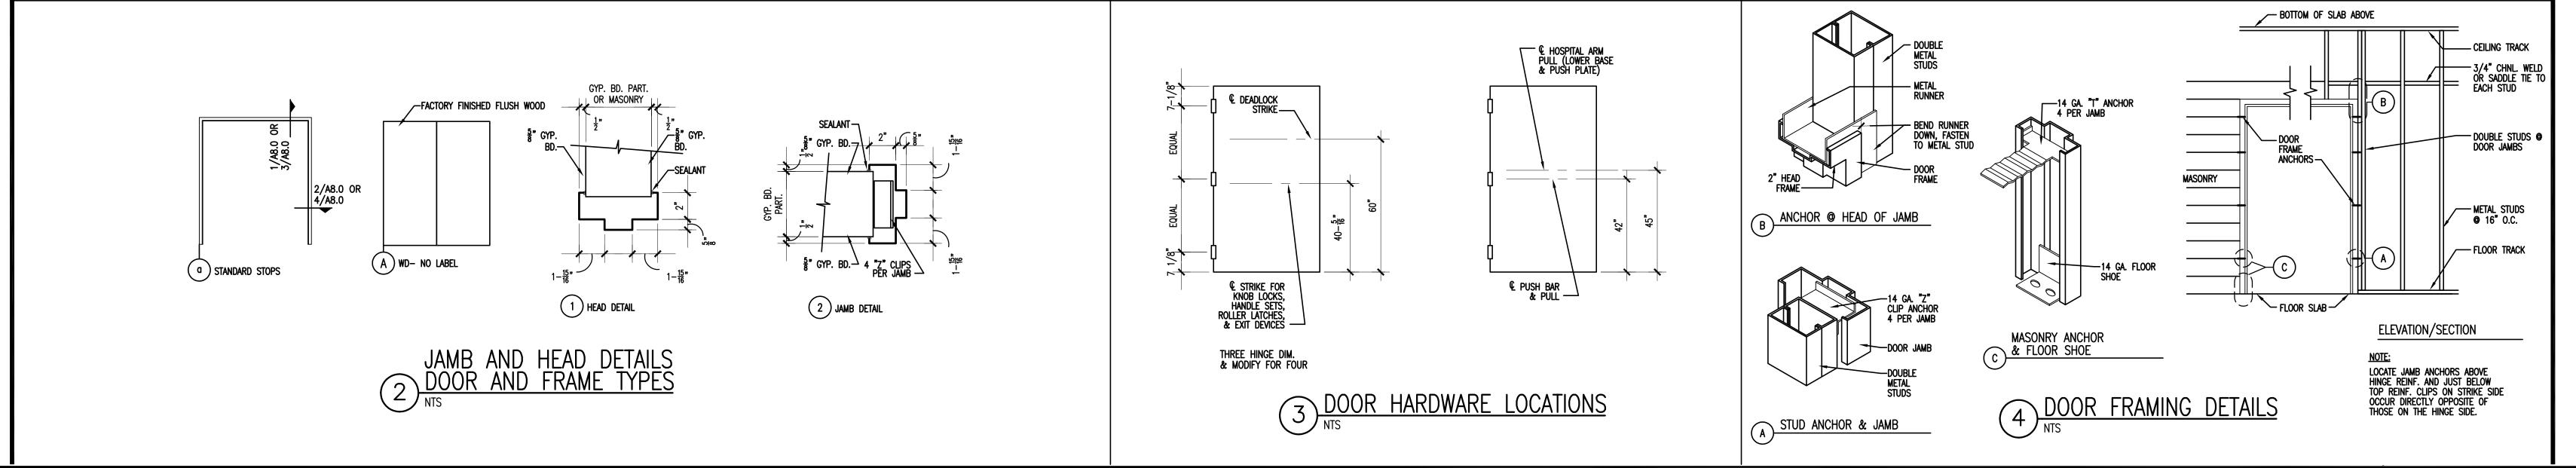
MINIMUM 7 YEAR WARRANTY 8. SUBMIT SCHEDULE, SPECS, PRODUCT DATA TO THE ARCHITECT FOR APPROVAL AS PER SECTION 01300.

STORAGE FUNCTION A. 3 MORTISE HINGES EACH DOOR LEAF FOR DOORS UP TO 3'-6" WIDE. FOR DOORS OVER 3'-6" WIDE PROVIDE 4 HINGES.

B. 1 MORTISE LOCKSET (LEVER), STOREROOM FUNCTION.
C. DOOR SILENCERS IN FRAME.

D. OVERHEAD STOP OR FLOOR STOP BUMPER AS REQUIRED.

DOOR SCHEDULE



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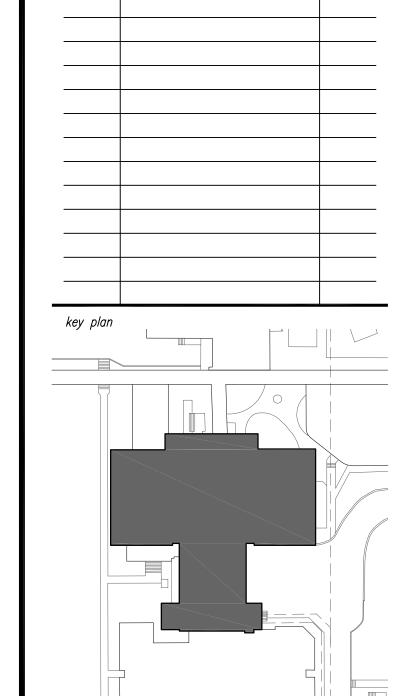
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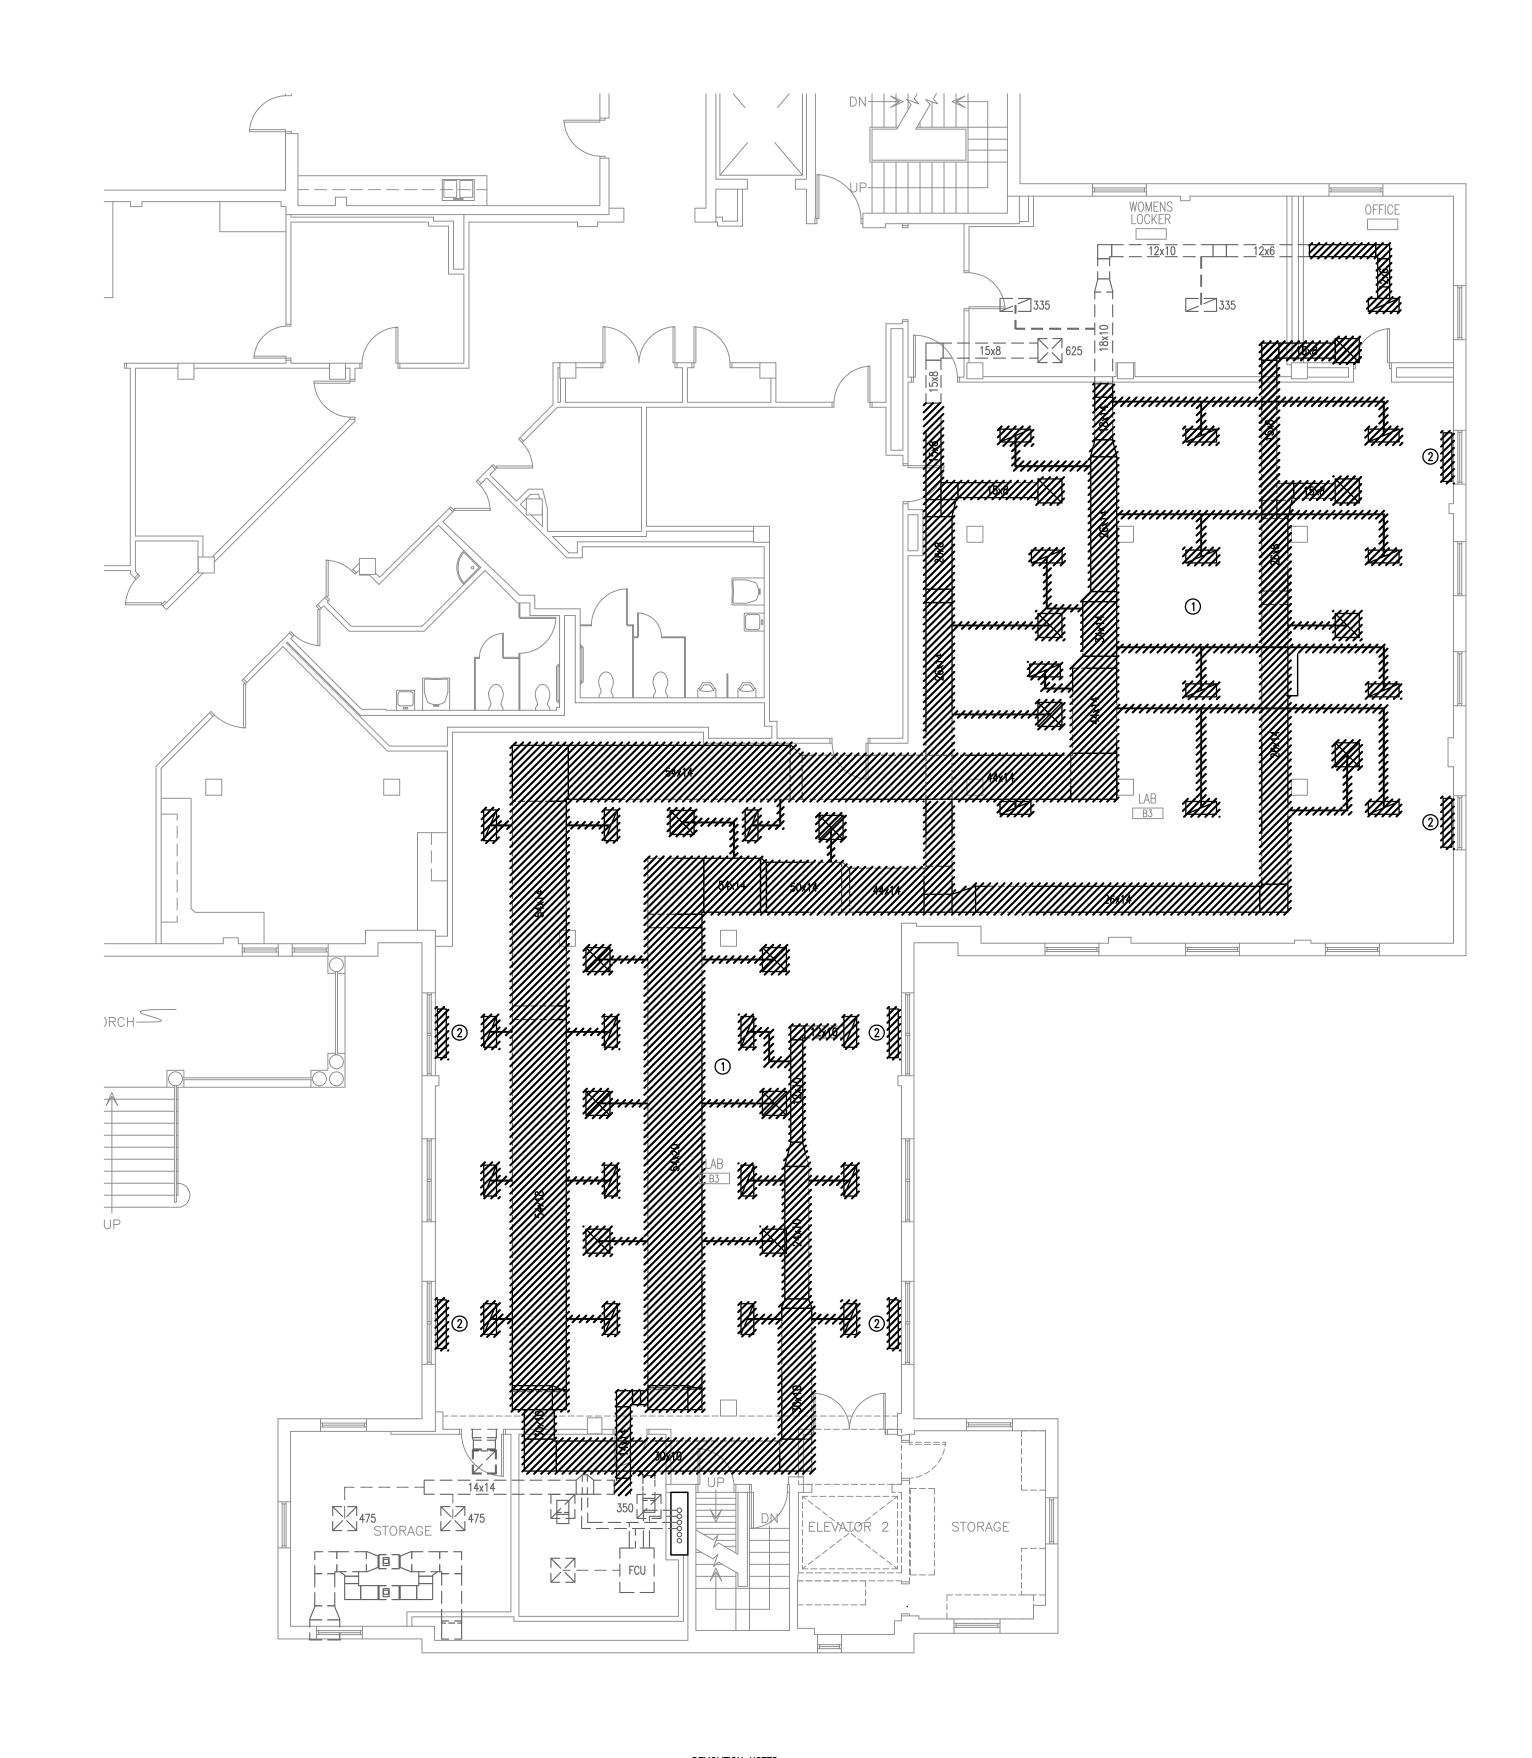


REFLECTED CEILING PLAN

sheet number

A7.1

drawn by TMW checked by



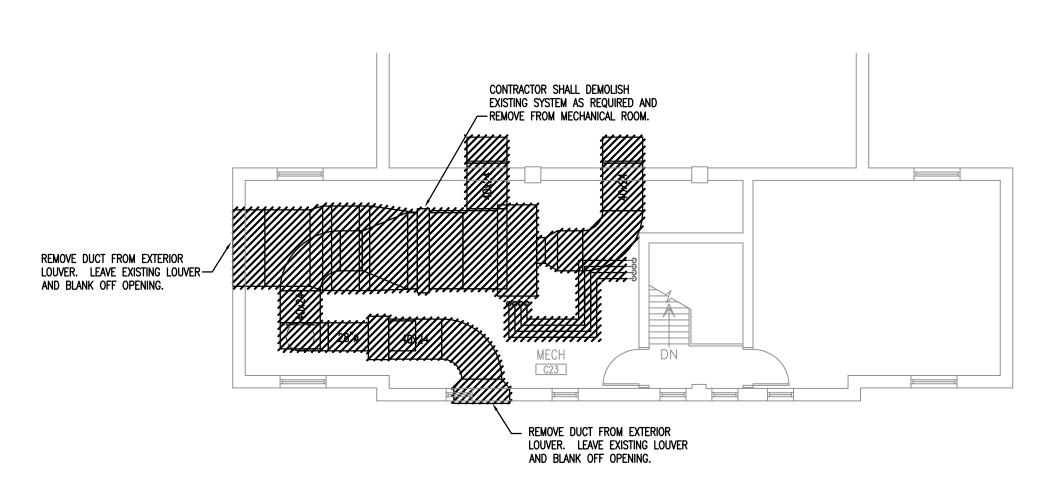
DEMOLITION NOTES:

1 REMOVE ALL HATCHED DUCTWORK AND GRILLES AS SHOWN.

2 REMOVE EXISTING FAN COIL UNIT LOCATED BELOW THE WINDOW AND CAP EXISTING CHILLED WATER AND HOT WATER PIPING BELOW SLAB.

PARTIAL FIRST FLOOR PLAN — HVAC DEMOLITION PLAN

1/8"=1'-0"



2 PARTIAL SECOND FLOOR PLAN - HVAC DEMOLITION PLAN 1/8"=1'-0"



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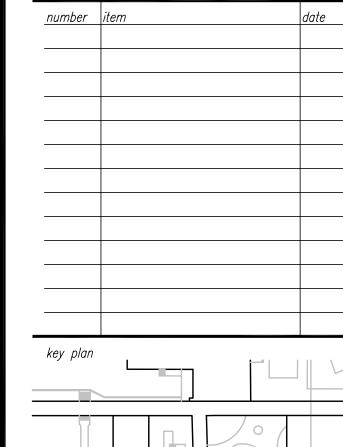
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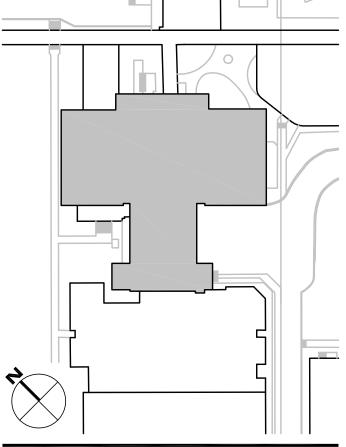
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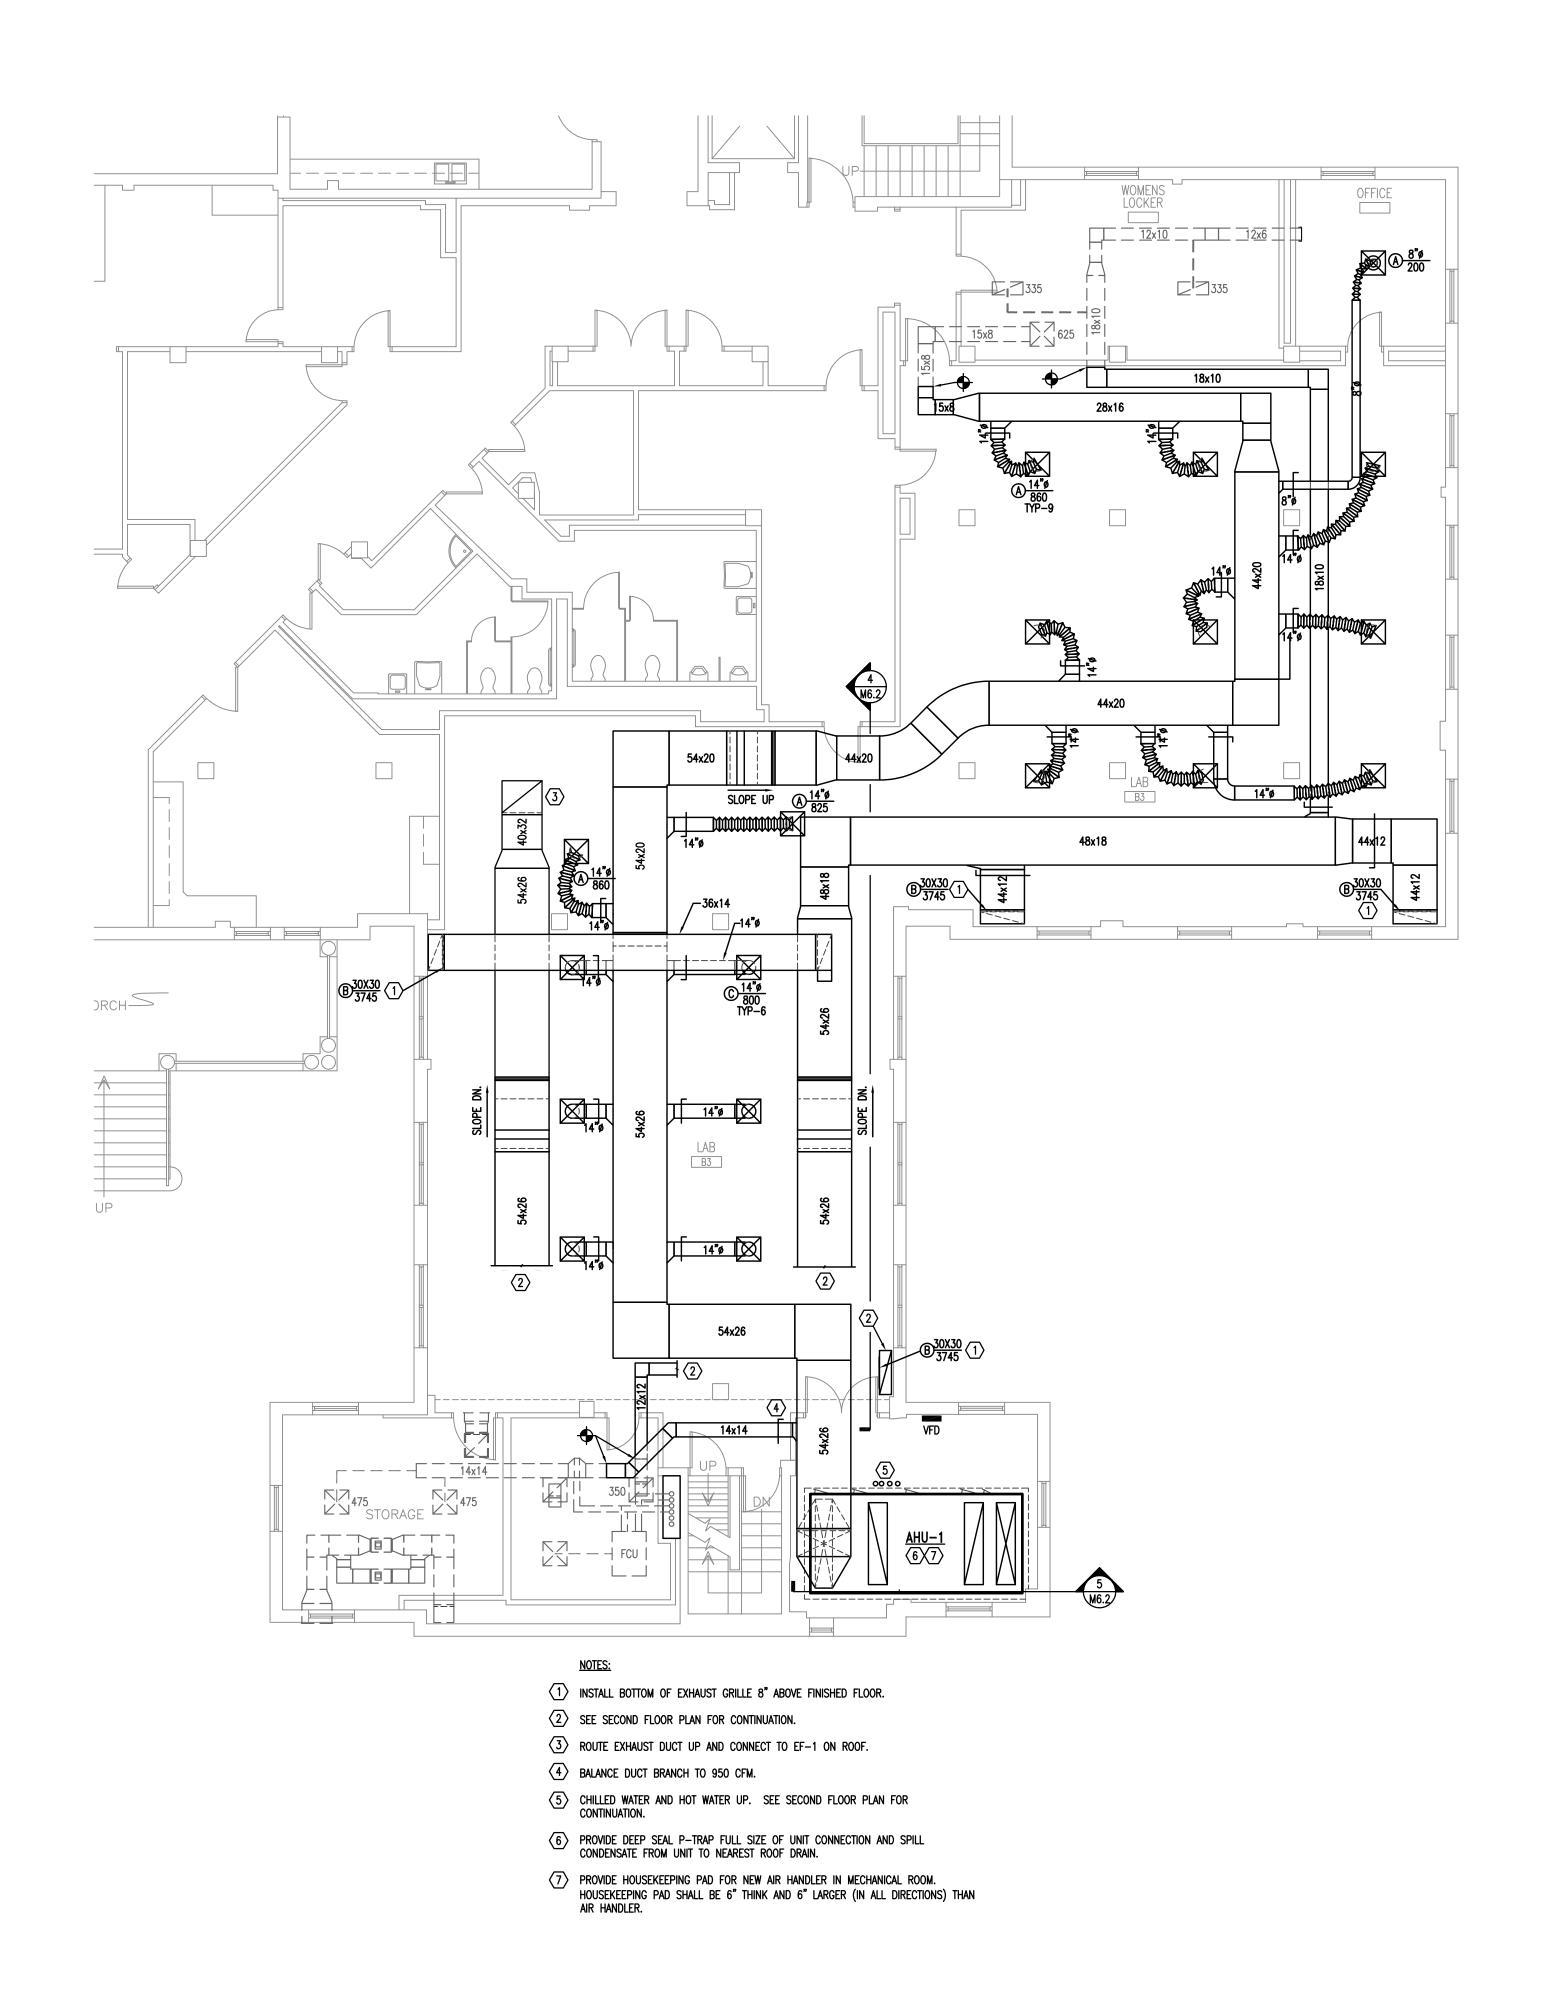


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PARTIAL FIRST & SECOND FLOOR
HVAC DEMOLITION

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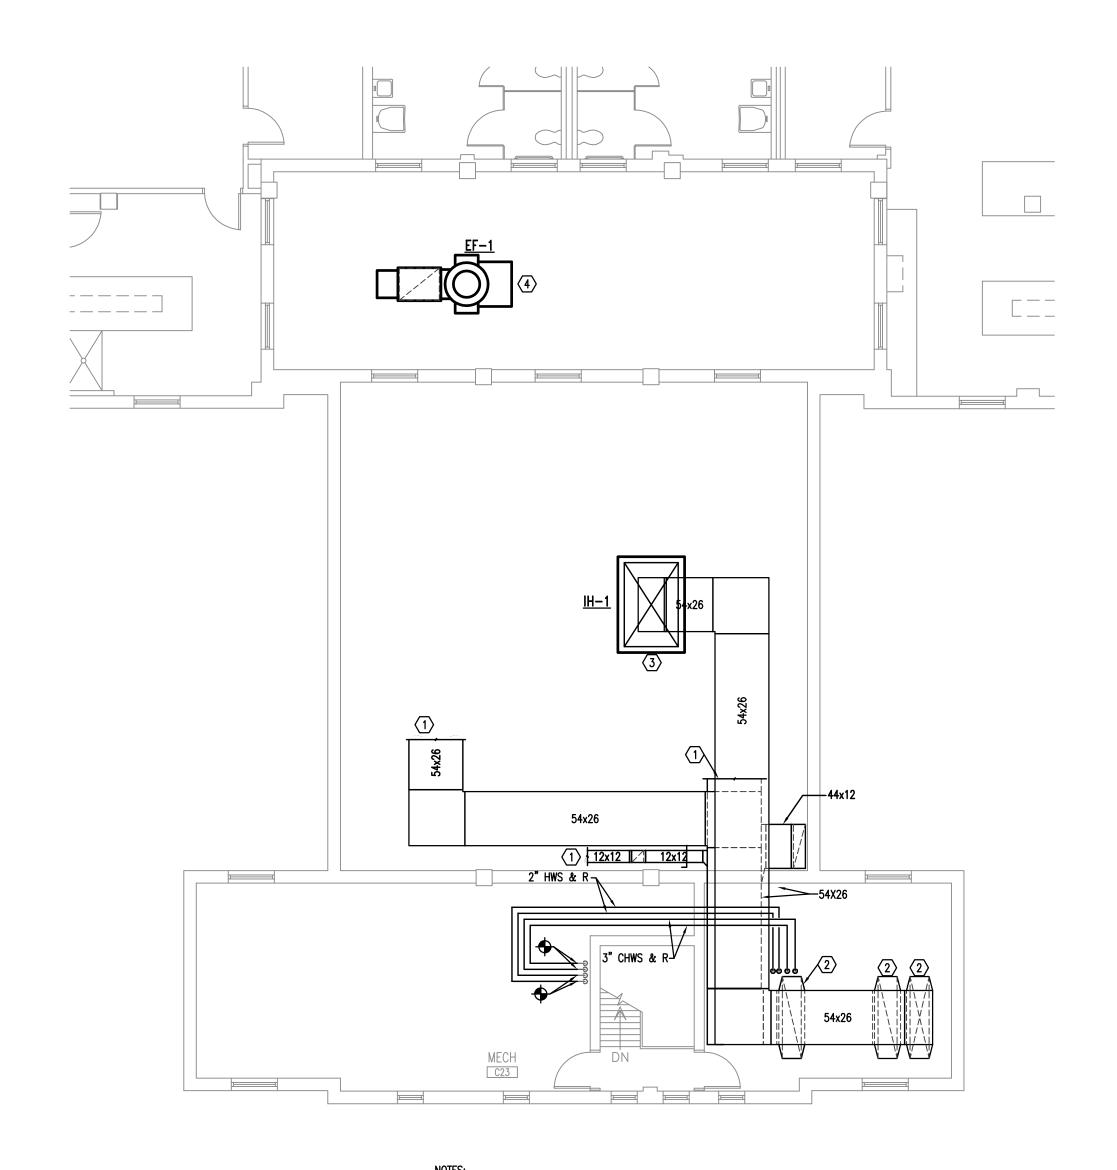
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drawn by JDR checked by JDR



PARITAL FIRST FLOOR PLAN — HVAC RENOVATION PLAN

1/8"=1'-0"



- 1) SEE FIRST FLOOR PLAN FOR CONTINUATION.
- TRANSITION DUCT IN VERTICAL TO CONNECTION SIZE ON UNIT. SEE SECTION THROUGH MECHANICAL ROOM FOR ADDITIONAL INFORMATION.
- CONTRACTOR HAS THE OPTION TO UTILIZE THE ROOF OPENING TO GET AIR HANDLER COMPONENTS INTO THE NEW MECHANICAL ROOM.
- CONTRACTOR SHALL REMOVE EXISTING ROOF CURB AND INSTALL NEW CURB TO SUPPORT EF-1 ON ROOF IN ACCORDANCE WITH MANUFACTURER'S REQUIREMENTS.

PARTIAL SECOND FLOOR PLAN — HVAC RENOVATION PLAN

1/8"=1'-0"



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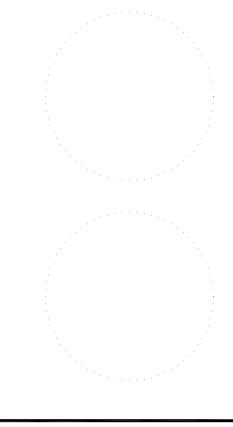
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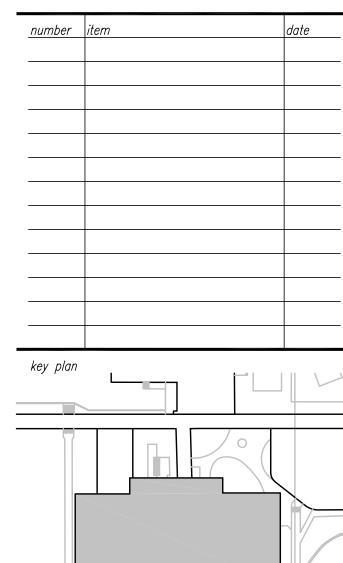
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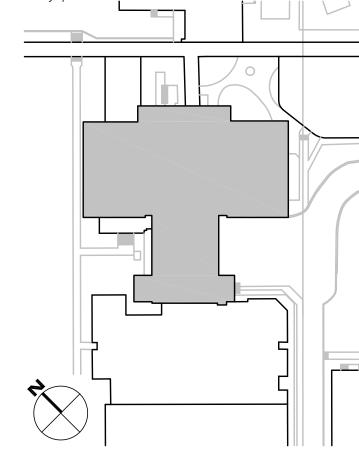
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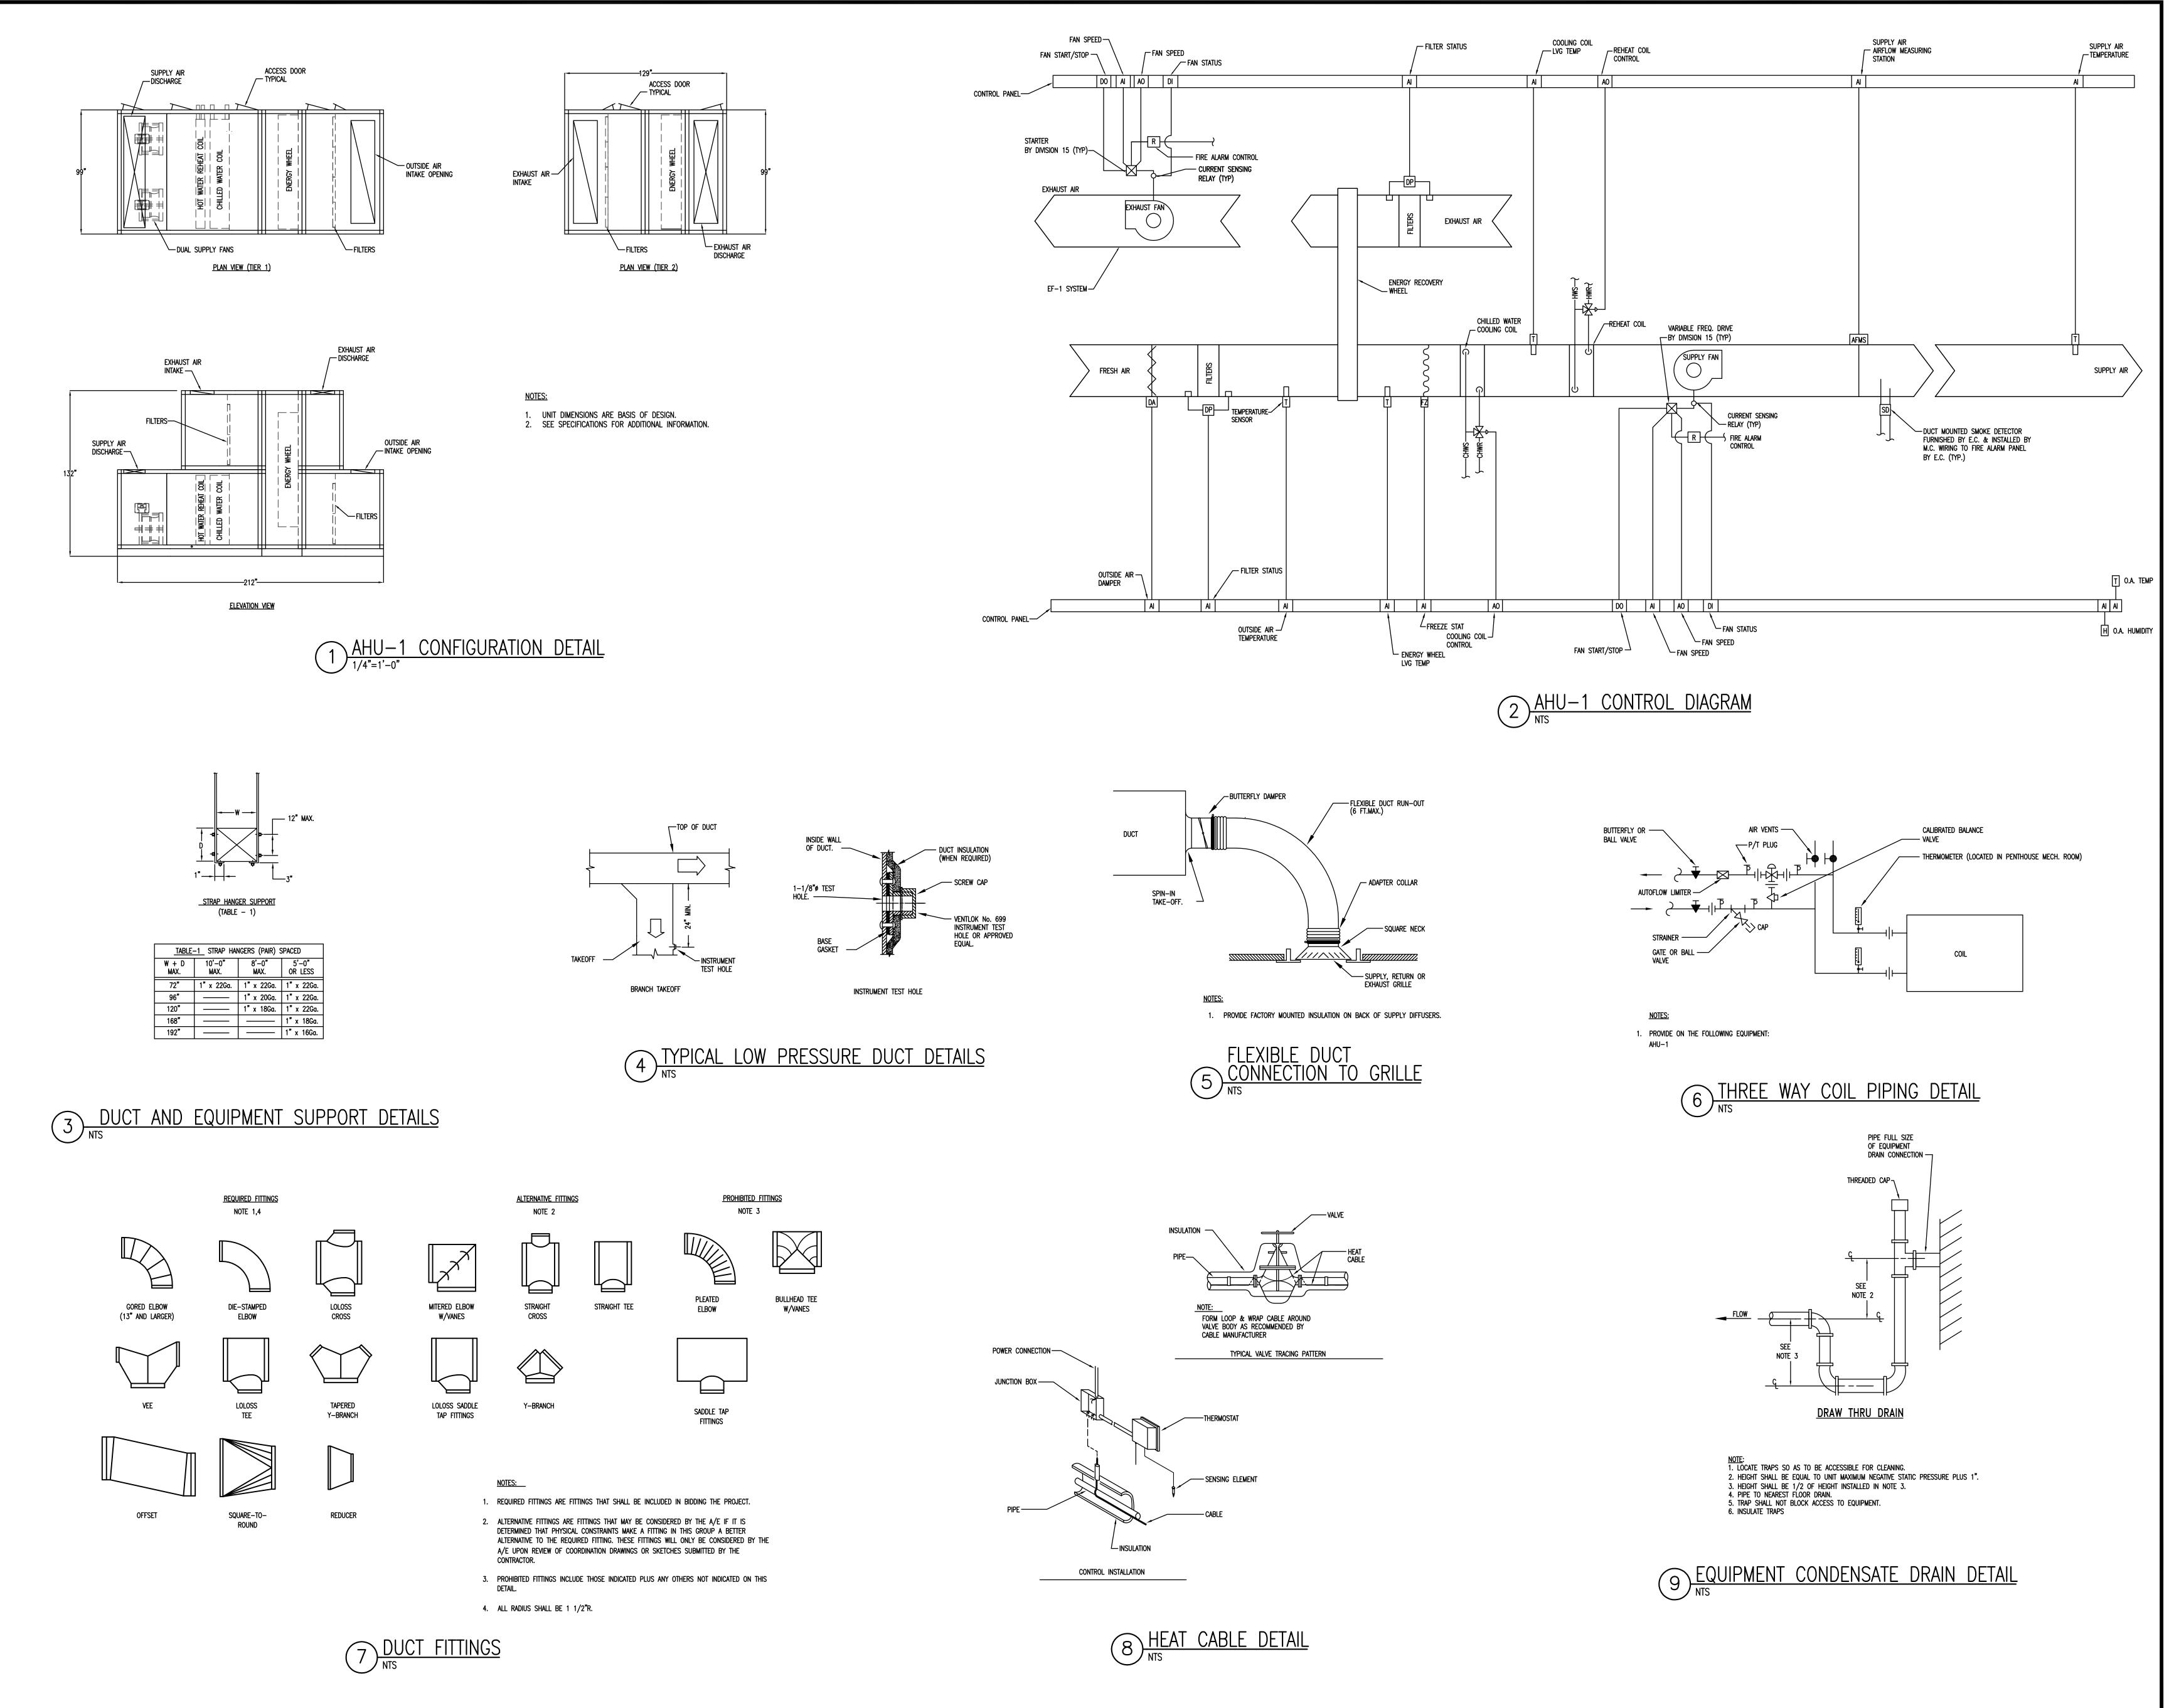


sheet title
PARTIAL FIRST & SECOND FLOOR
PLAN - HVAC RENOVATION

sheet number

**M2.1** 

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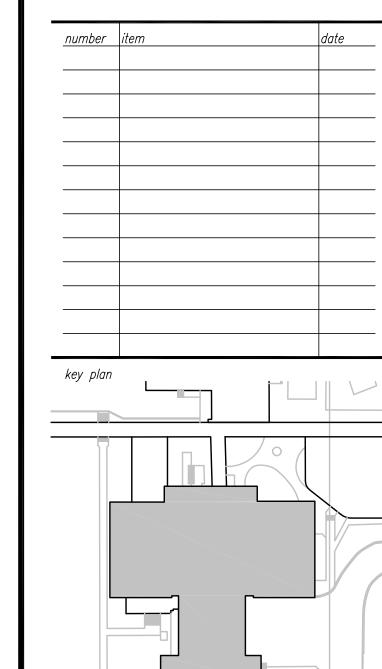
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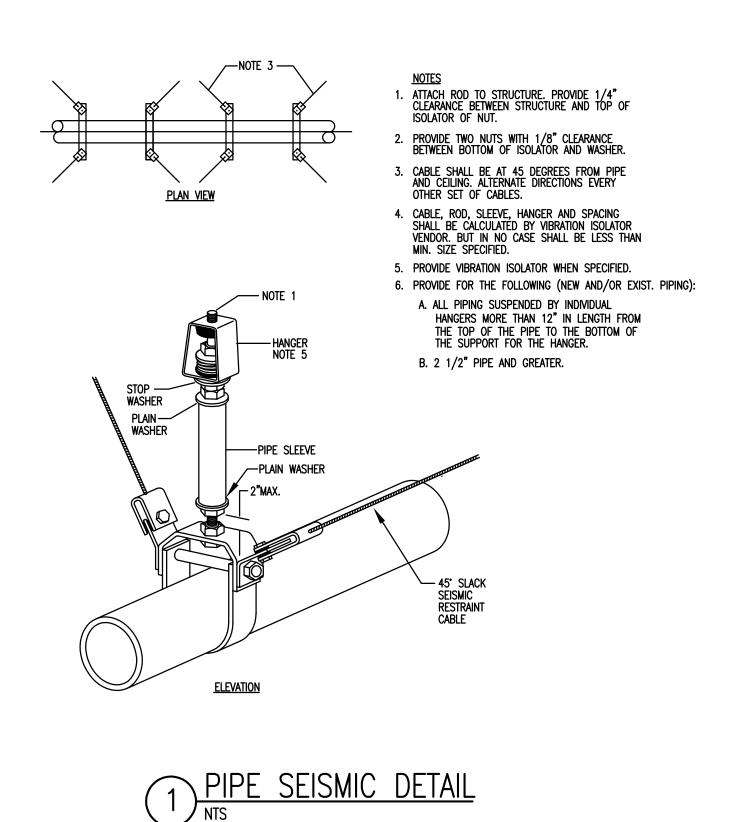
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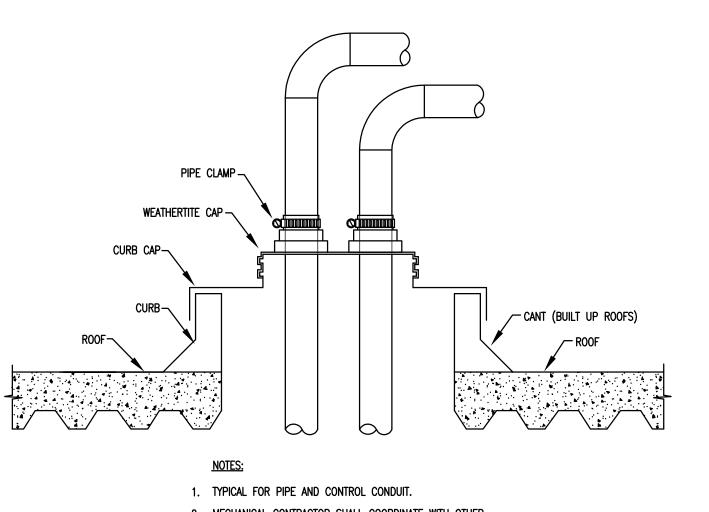


HVAC DETAILS
AND CONTROL SCHEMATICS

sheet number

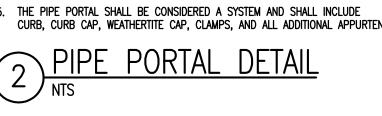
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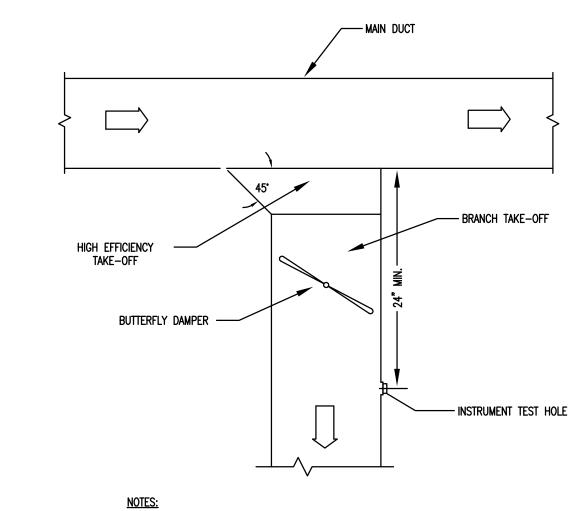




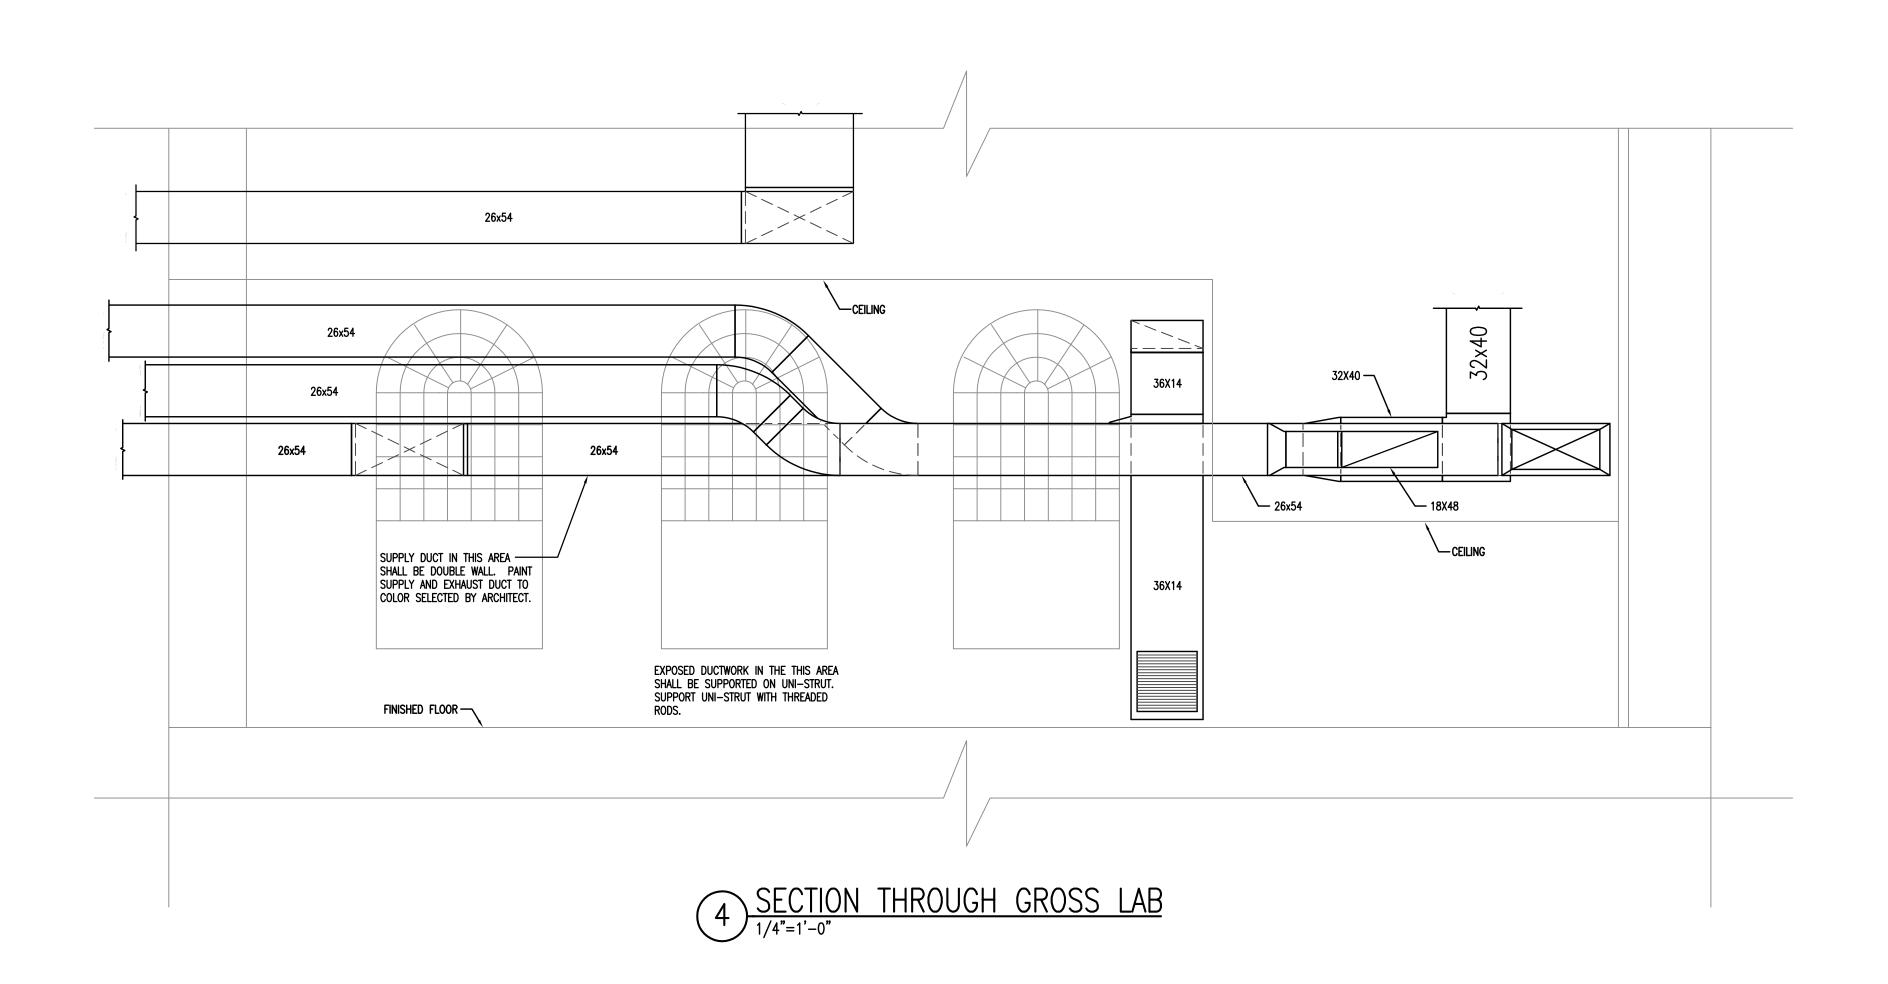
- MECHANICAL CONTRACTOR SHALL COORDINATE WITH OTHER TRADES AND OVERSIZE TO ALLOW INSTALLATION OF THE FOLLOWING:

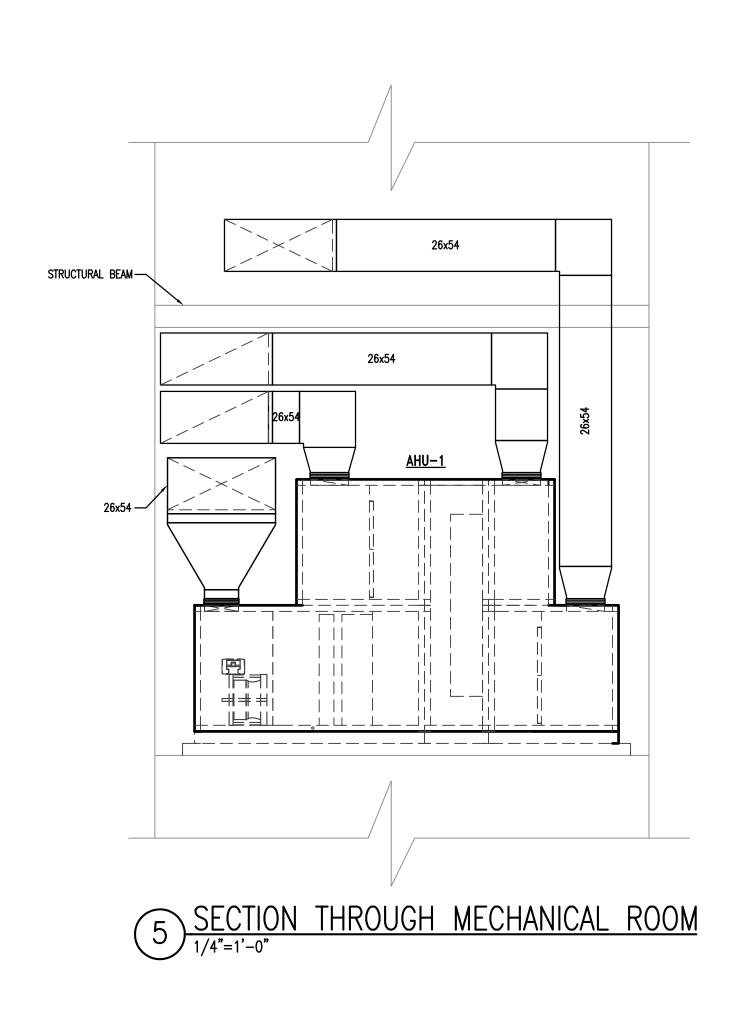
   a. ELECTRICAL CONDUIT.
- 3. MECHANICAL CONTRACTOR SHALL PROVIDE OPENINGS FOR INSTALLING CONTRACTOR AND SEAL ALL PENETRATIONS
- 4. INSTALLATION MAY VARY WITH NUMBER OF PIPES PER PORTAL. CONSULT MFGR'S RECOMMENDATIONS FOR INSTALLATION INSTRUCTIONS
- 5. THE PIPE PORTAL SHALL BE CONSIDERED A SYSTEM AND SHALL INCLUDE CURB, CURB CAP, WEATHERTITE CAP, CLAMPS, AND ALL ADDITIONAL APPURTENANCES.





1. HIGH EFFICIENCY TAKE—OFF SHALL BE DESIGNED WITH A RECTANGULAR OPENING AND AN APPROXIMATE 45° SLOPE ON THE BODY. A FLANGE IS TURNED OUT ON ALL FOUR SIDES WITH EACH CORNER BEING FILLED. THE FLANGE ALSO HAS PRE—PUNCHED HOLES FOR EASY INSTALLATION. THERE IS A CLOSED CELL NEOPRENE GASKET APPLIED TO THE FLANGE TO ASSURE A TIGHT SEAL. PROVIDE INTEGRAL BALANCING DAMPER IN TAKE—OFF.





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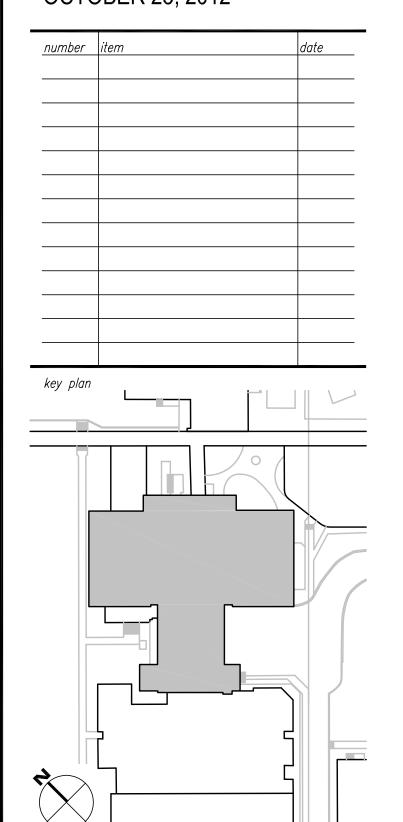
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sheet title
HVAC DETAILS

sheet number

	ABBREV	TATIONS	
BV  FF SHP SHP SC-1  CHWS CHWR  DD  B EAT ELEC EWB EWT  FR HWS HWR HP AT LWB LWT  LWB LWT  LWB LWT  LWB LWT	Above Above Finished Floor Brake Horsepower Cubic Feet Per Minute Cooling Coil No. 1 Chilled Water Supply Chilled Water Return Duct Smoke Detector Dry Bulb Temperature Entering Air Temperature Electric or Electrical Entering Air Wet Bulb Entering Water Temperature Energy Recovery Wheel No. 1 Filter Type No. Floor Humidifier No. 1 Hot Water Supply Hot Water Return Horsepower Leaving Air Temperature Leaving Air Wet Bulb Leaving Water Temperature Maximum	MBH MIN MPS N/A NIC NTS OA OBD OD PD RH-1 RA RET RH SA SEER SHT SP SPEC SPL T T-1 TEMP TSTAT TYP VFD WB WPD	Thousand BTU/Hr (thousands) Minimum Medium Pressure Steam Not Applicable Not in Contract Not To Scale Outside Air Opposed Blade Damper Outside Diameter Pressure Drop Re—Heat Coil No. 1 Return Air Return Relative Humidity Supply Air Seasonal Energy Efficiency Ratio Sheet Static Pressure Specifications Supply Thermostat Tank No. 1 Temperature Thermostat Typical Variable Frequency Drive Wet Bulb Temperature Water Pressure Drop (in. w.g)

### MECHANICAL GENERAL NOTES

DO NOT SCALE DRAWINGS; SEE ARCHITECTURAL DRAWINGS AND REFLECTED CEILING PLANS FOR EXACT LOCATIONS OF DOORS, WINDOWS, CEILING, DIFFUSERS, ETC.
 EXTEND ALL DRAIN LINES TO EXTERIOR AND SPILL ON GRADE. ROUTE TO AVOID INTERFERENCE WITH PASSAGEWAYS. CONDENSATE DRAINS SHALL BE TRAPPED. SLOPE DRAIN LINES 1/8" PER FOOT.

3. ALL PIPING AND DUCTWORK INSULATION SHALL BE RUN CONTINUOUSLY THROUGH FLOORS, ROOFS AND PARTITIONS EXCEPT WHERE PROHIBITED BY FIRE CODES.

4. ALL PIPING SHALL BE SUPPORTED IN ACCORDANCE WITH THE SPECIFICATIONS AND FURTHER SUPPORTS OR HANGERS SHALL BE ADJACENT TO ELBOWS, TO PREVENT WEIGHT OF PIPING BEING PLACED ON THE EQUIPMENT. SUPPORT DETAILS SHALL BE SUBMITTED TO THE MECHANICAL ENGINEER.

ALL PIPING AND DUCTWORK LOCATIONS SHALL BE COORDINATED WITH THE WORK UNDER OTHER DIVISIONS OF THE SPECIFICATIONS TO AVOID INTERFERENCE.
 ALL PIPING, DUCTS, VENTS, ETC. EXTENDING THRU EXTERIOR WALLS AND ROOFS SHALL BE FLASHED AND COUNTERFLASHED.
 PROVIDE ALL TRANSITIONS REQUIRED FOR INSTALLATION OF DUCT, EXHAUST FANS, AND ALL OTHER EQUIPMENT AND APPURTENANCES.

8. ALL DUCT IS GALVANIZED SHEET METAL EXCEPT AS NOTED.9. DUCT SIZES ARE CLEAR INSIDE DIMENSIONS.

### MECHANICAL DEMOLITION NOTES

DRAWINGS SHOW GENERAL INTENT OF DEMOLITION. QUANTITIES, LOCATIONS, SIZES AND EQUIPMENT ARE SHOWN TO INDICATE TYPE OF SYSTEM INSTALLED AND DOES NOT NECESSARILY REPRESENT EXACT CONDITIONS. CONTRACTOR SHALL FIELD VERIFY BEFORE BIDDING.

2. DEMOLITION OF EQUIPMENT, SYSTEMS, AND COMPONENTS SHALL INCLUDE ALL SUPPORTS, PADS, HANGERS, INSULATION, CONTROLS, STARTERS, ACCESSORIES, AND APPURTENANCES NOT REQUIRED FOR THE INSTALLATION OF THE NEW SYSTEM.

3. WHEN PARTIAL DEMOLITION OF A SYSTEM IS INDICATED, THE PART OF THE SYSTEM SHOWN TO REMOVED SHALL BE REMOVED TO THE ACTIVE MAIN OR BRANCH IF NOT REQUIRED FOR THE INSTALLATION OF THE NEW SYSTEM. THE ACTIVE MAIN OR BRANCH SHALL BE REPAIRED TO MATCH NEW INSTALLATION AS MUCH AS PRACTICAL. IF SYSTEM IS INSULATED, INSULATION SHALL BE PATCHED AND FINISHED REPAIR (IE: VAPOR BARRIER, COATING, ETC.)

REMOVAL OF SYSTEMS SHALL INCLUDE COMPLETE SYSTEM WHENEVER PRACTICAL.
IF NOT, SYSTEM (IE: PIPE, CONDUIT, ETC.) SHALL BE REMOVED TO 1 INCH
BELOW SURFACE.

		Н	IVAC LEGEND		
SYMBOL	DESCRIPTION	SYMBOL	DESCRIPTION	SYMBOL	DESCRIPTION
T	TEMPERATURE SENSOR OR THERMOSTAT	100000000000000000000000000000000000000	CEILING SUPPLY DIFFUSER, RETURN GRILLE W/ FLEX DUCT CONN. FOR RETURN OR EXHAUST AIR; SEE "DIFFUSER & GRILLE SCHEDULE"	18x12 12x12	TRANSITION, FLAT ON BOTTOM (FOB) FLAT ON TOP (FOT, IF APPLICABLE)
8	WALL SWITCH		EXISTING DUCT WORK TO REMAIN		TURNING VANES
(H)	WALL HUMIDISTAT	*//////	EXISTING DUCT WORK TO BE REMOVED	<del>-</del>	DUCT SMOKE DETECTORS
•	CONNECT TO EXISTING		DUCT TURNING DOWN	CR	CONCEALED REGULATOR
18x12	RECTANGULAR DUCT SIZE, FIRST FIGURE IS SIDE SHOWN		DUCT TURNING UP		MANUAL VOLUME DAMPER
{ 18"ø }	ROUND DUCT SIZE	——————————————————————————————————————	UNION	<u>A</u> 6"ø 100	A — DIFFUSER TAG 6"Ø — NECK SIZE 100 — CFM
<del>-</del>	CHANGE OF ELEVATION, RISER (R), DROP (0)		STRAINER		GATE VALVE
<u> </u>	ACOUSTICAL LINING INSULATION		STRAINER WITH BLOW OFF		CONTROL VALVE, TWO WAY
	FLEXIBLE DUCT		ECCENTRIC REDUCER FLAT ON TOP		END CAP
CHWS	CHILLED WATER SUPPLY		TEE OUTLET UP	<del>-+</del>	ELBOW TURNED DOWN
CHWR	CHILLED WATER RETURN		TEE OUTLET DOWN	-+0	ELBOW TURNED UP
	CONCENTRIC REDUCER				ECCENTRIC REDUCER FLAT ON BOTTOM

FAN SCHEDULE														
TAG	TYPE	CAPACITY	E.S.P.	MOTOR			ELECTRICAL	EMERGENCY	MANUFACTURER*	MODEL NO.				
IAG	TIPE	CFM	(IN. WG.)	WATTS	HP	RPM	(VOLTS/PHASE)	POWER	MANUFACTURER	MODEL NO.	NOTES			
EF-1	MIXED FLOW	16000	3.0		15	1800	460/3	NO	TWIN CITY FAN & BLOWER	BAIFE	3,5,6			
* APPROVED EQUAL MANUFACTURER ACCEPTABLE  1. MOTORIZED BACKDRAFT DAMPER  5. SEISMIC ROOF CURB  2. GRAVITY BACKDRAFT DAMPER  6. STARTER  3. DISCONNECT SWITCH														

	A	IR DIS	STRIBU	JTION	SCHED	ULE		
TAG	DESCRIPTION	NECK	MODULE SIZE	MOUNT	CONSTR.	MFGR*	MODEL	NOTES
Α	SQUARE PLAQUE CEILING SUPPLY	AS SHOWN	24X24	LAY-IN	ALUMINUM	PRICE	SERIES ASPD	2,3
В	SIDEWALL RETURN/EXHAUST	AS SHOWN	AS SHOWN	SIDEWALL	ALUMINUM	PRICE	SERIES 95	1,3
С	SQUARE PLAQUE CEILING SUPPLY	AS SHOWN	24X24	SURFACE	ALUMINUM	PRICE	SERIES ASPD	2,3

\* APPROVED EQUAL MANUFACTURER ACCEPTABLE

1. FURNISH WITH OPPOSED BLADE DAMPER
2. 4-WAY DEFLECTION UNLESS NOTED OTHERWISE
3. BAKED ENAMEL OFF-WHITE FINISH
4. PROVIDE TBP PANEL
5. PROVIDE RADIATION DAMPER AT GRILLE NECK
4. PROVIDE TBP PANEL

	FILTER SCHEDULE														
TAG	TAG SYSTEM TYPE CAPACITY (CFM) FILTER DEPTH (INCHES) RESULTIVE (FFM) SYSTEM SYSTEM TYPE (CFM) SYSTEM														
F-1A	AHU-1	PRE-FILTER	5300	2"	500	FARR	30/30	1							
1. TEST METHO	OD: ASHRAE 52.1-	92 Standard													

	COIL SCHEDULE																		
			CAPACITY	MAX. AIR	MIN. FACE	AIR PRESS		CAPACITY			AIR TEMP	ERATURE			WATER	₹		MAXIMUM	
TAG	LOCATION	LOCATION	CFM	VĘLOCĮTY	, AREA	, DROP (	TOTAL	SENS.	KW	ENTE	RING	LEAV	/ING	ENTERING	LEAVING	GPM	PRESS DROP	NO. OF	NOTES
			CIWI	(FPM)	(SQ. FT.)	(IN. WG.)	MBH	MBH	I/W	DB 'F	WB 'F	DB °F	WB 'F	TEMP. *F	TEMP. *F	O W	(FT. WATER)	FINS/IN.	
CC-1	AHU-1	MECH RM.	16000	505	31.7	0.86	871.0	472.0		77.7	68.8	50.5	50.4	44	58.5	120.0	8.5	8	
RH-1	AHU-1	MECH RM.	16000	505	31.7	0.07	564.1			48.7		80.3		180	160	57.9	5.4	9	1
I. COIL IN REI	HEAT POSITION		-		-	-											-		

	AIR HANDLER UNIT SCHEDULE															
740	CAPACITY	MINIMUM	FAN	SUPPLY FAN SP (IN. W.G.) MOTOR					ELECTRICAL	AIR	COOLING	FIRST_STAGE	REHEAT	40050000150		DEMADIZE
TAG	CFM	0.A.	FAN CFM	Fan Type	TOTAL	EXT	BHP	HP	VOLTS/PHASE VOLUME CONTROL		COIL EQ. NO.	Filter Eq. No.	COIL EQ. NO.	ACCESSORIES	MANUFACTURER	REMARKS
AHU-1	16000	16000	8000	AF	5.21	2.50	13.05	15.0	460/3	VFD	CC-1	F-1A	RH-1	EW-1	JCI SOLUTION INDOOR AHU	1,2

									El	NTHALF	PY WHE	EEL SC	HEDUL	E							
TAG	SYSTEM	SUPPLY CFM	EXHAUST CFM	SUMMER CONDITIONS SUPPLY AIR EFFECTIVENESS (%)								WINTER CONDITIONS SUPPLY AIR EXHAUST AIR EFFECTIVENESS (%)								MANUFACTURER	REMARKS
		O	<b>37</b>	ENT. DB	ENT. WB	LVG. DB	LVG. WB	ENT. DB	ENT. WB	SENSIBLE	LATENT	ENT. DB	ENT. WB	LVG. DB	LVG. WB	ENT. DB	ENT. WB	SENSIBLE	LATENT		
EW-1	AHU-1	16000	16000	95	80	77.7	68.8	68.0	60.0	64.15	60.02	21.0	20.0	48.7	42.5	66.0	54.0	63.66	59.62	JCI	

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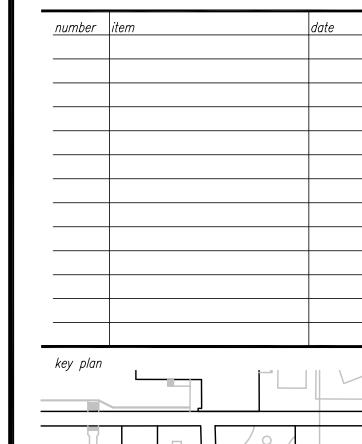
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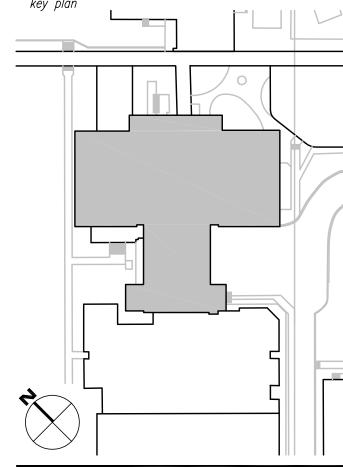
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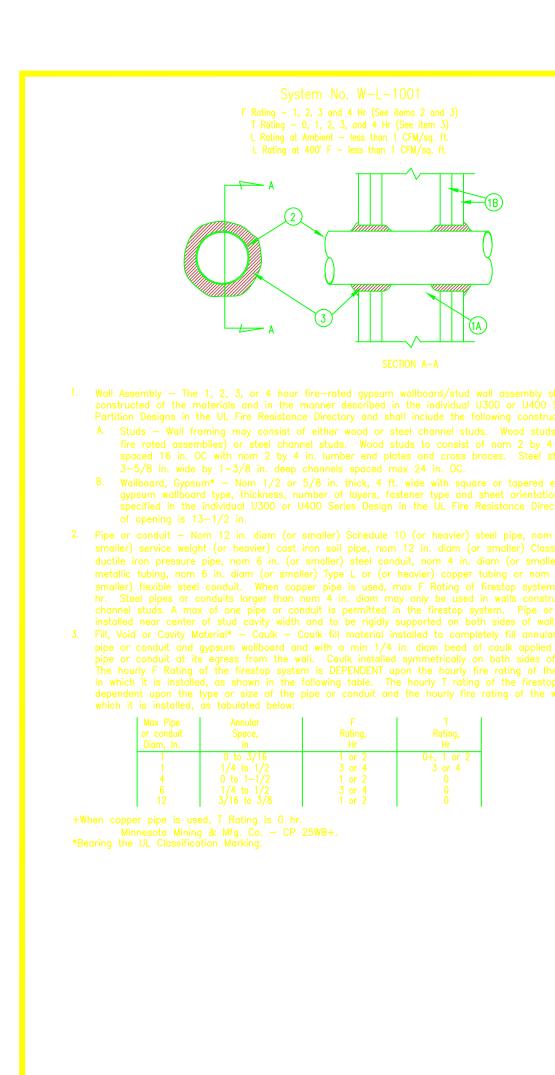


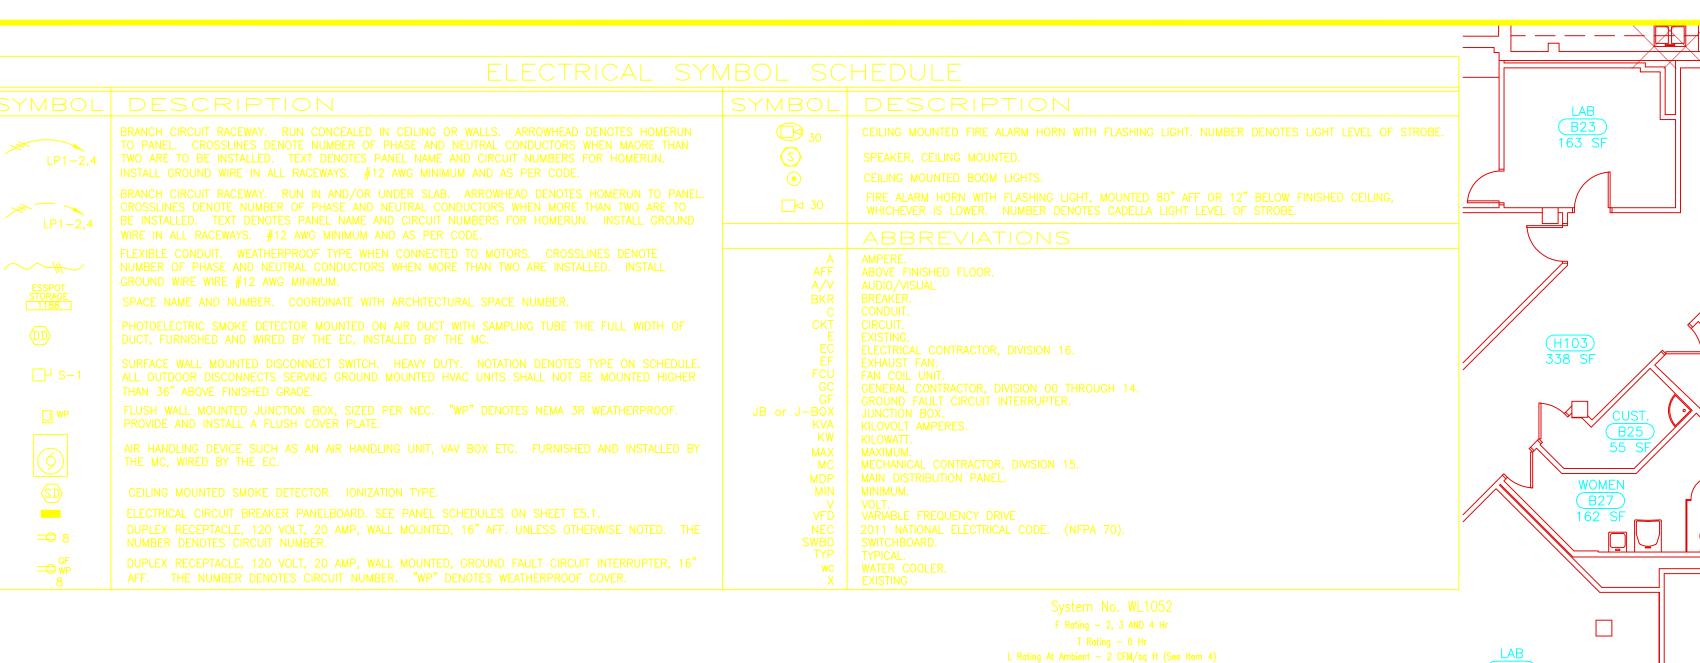
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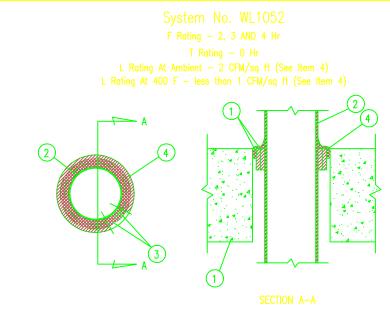
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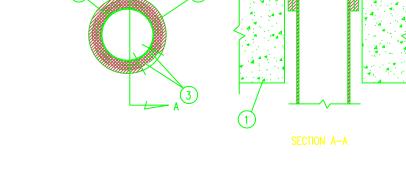
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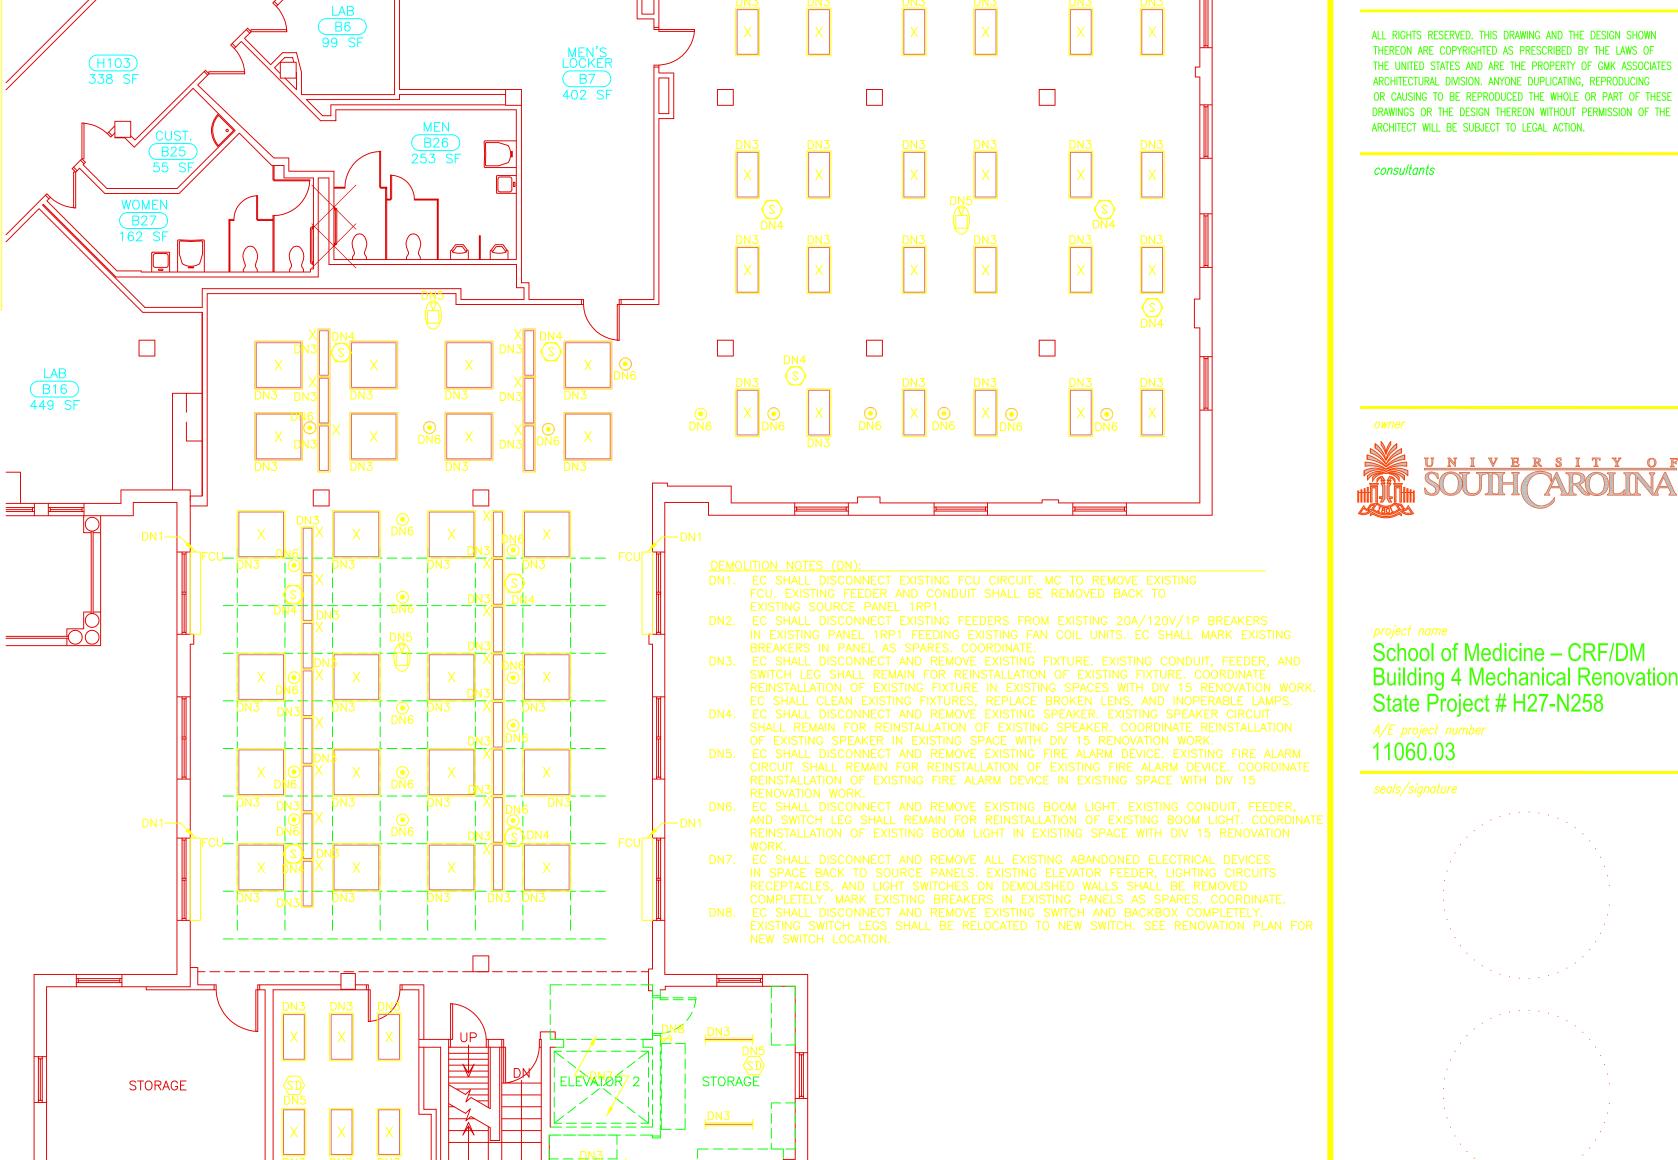
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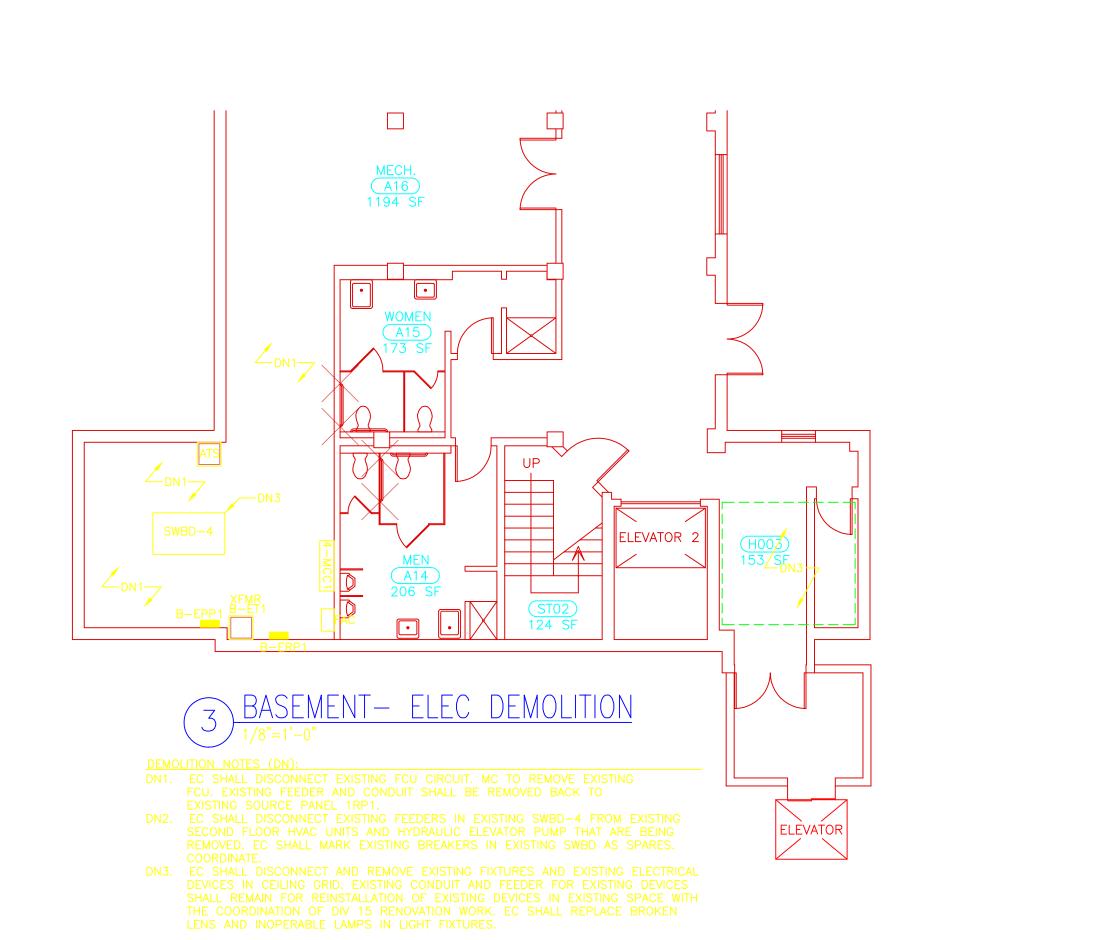


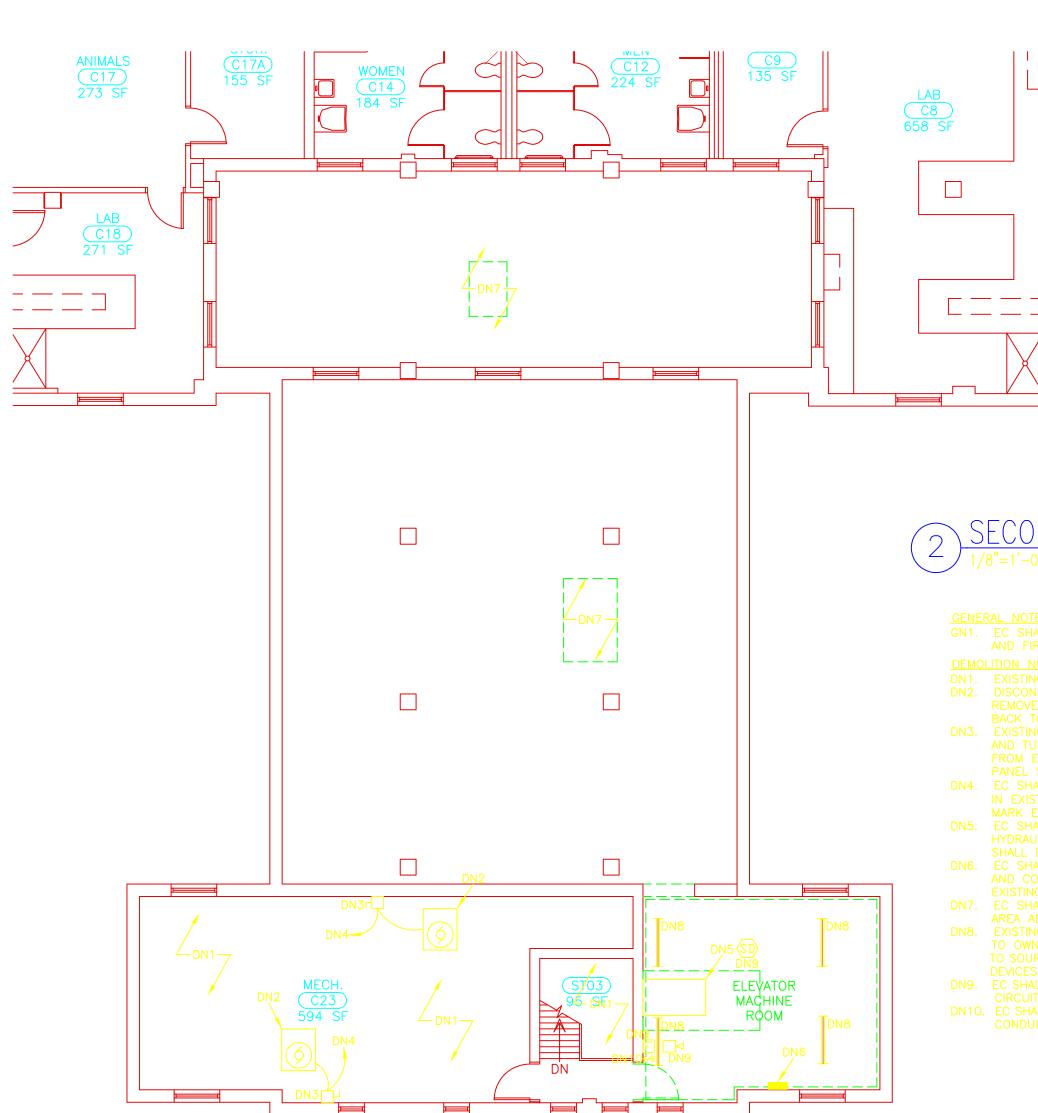












SECOND FLOOR — ELEC DEMOLITION

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State Project # H27-N258

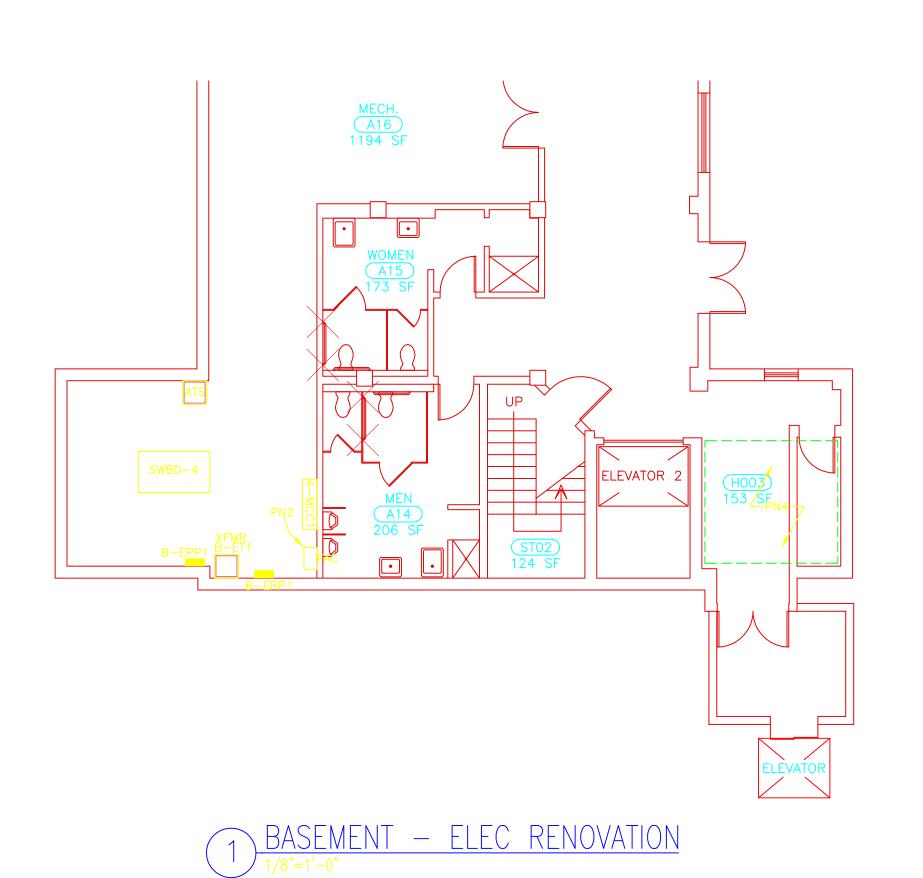
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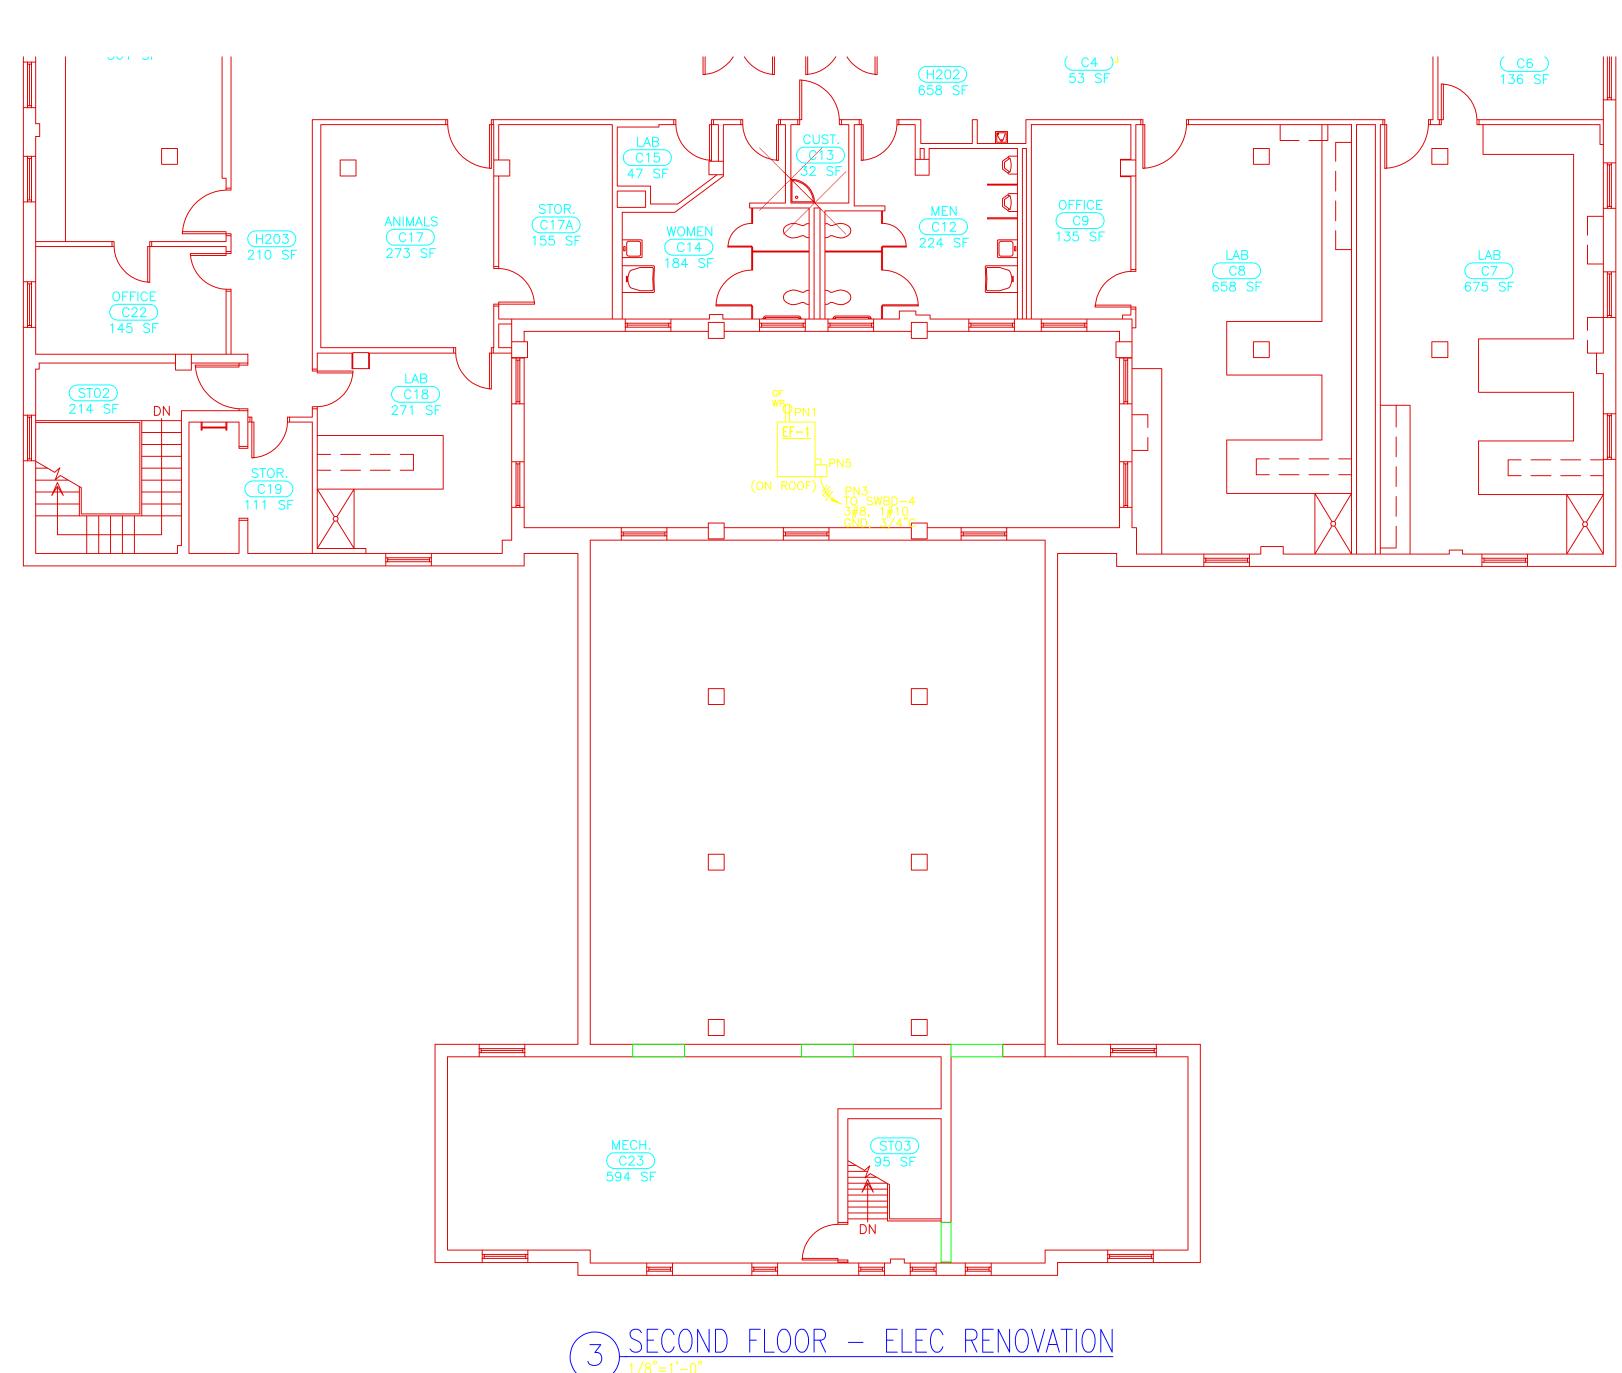
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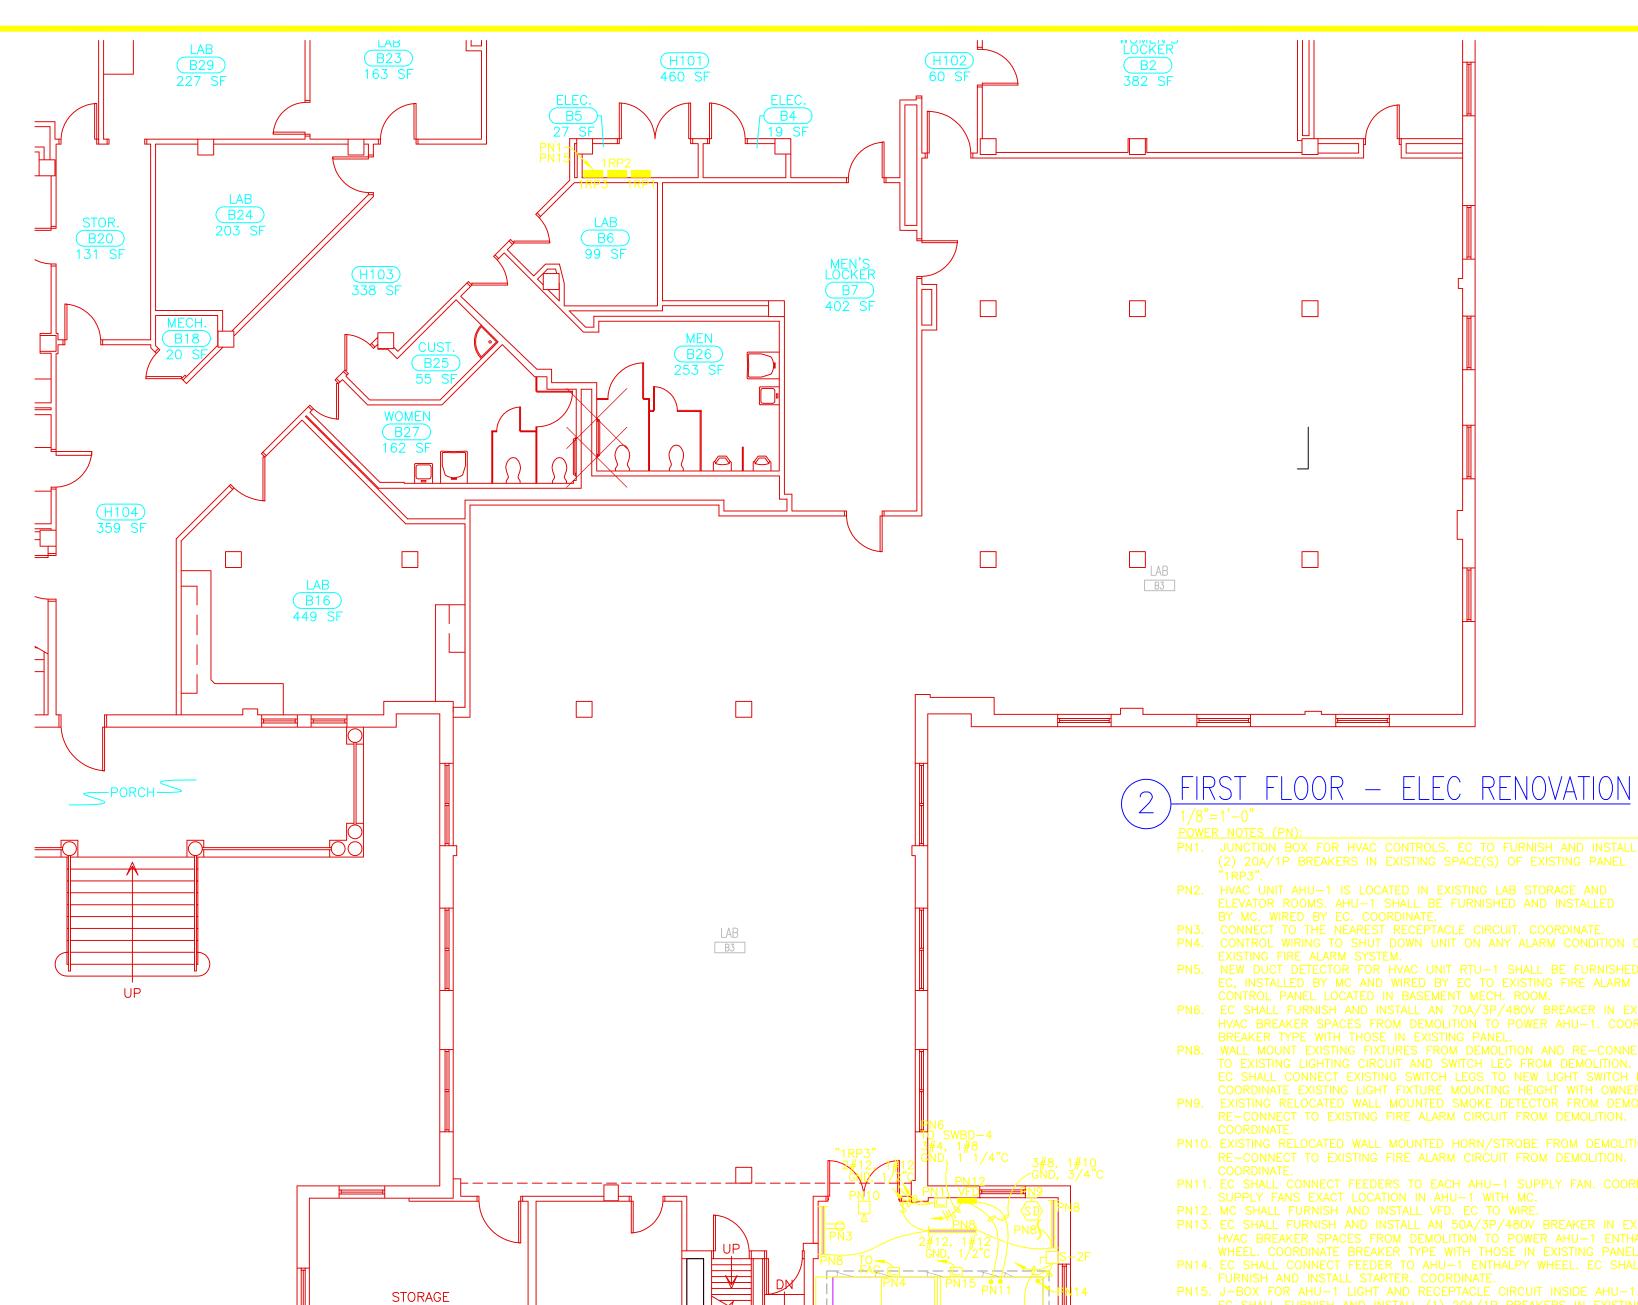
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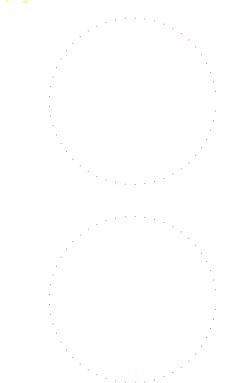
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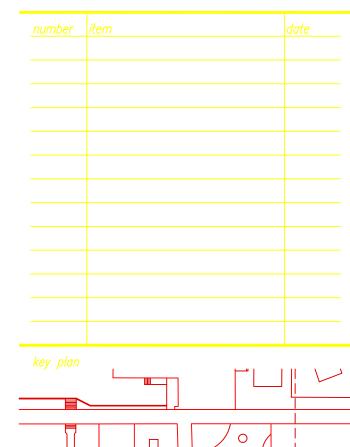


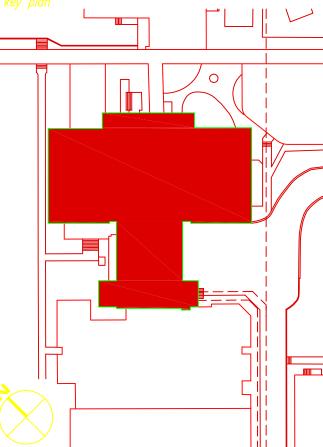
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